
General Notes:

- ALL WORK SHALL CONFORM TO THE LATEST FLORIDA BUILDING CODE, THE NFPA LIFE SAFETY CODE, AND ALL OTHER APPLICABLE CODES AND ORDINANCES. OBTAIN ALL REQUIRED PERMITS FOR THE PROPER LEGAL EXECUTION OF THE WORK DESCRIBED IN THESE DRAWINGS AND SPECIFICATIONS.
- PROVIDE A CONTINUOUS LOAD PATH FROM TRUSSES OR RAFTERS TO FOUNDATION FOR ALL NEW CONSTRUCTION. IF ANY DISCREPANCIES, CALL DESIGNER FOR CLARIFICATION BEFORE PROCEEDING.
- THE CONTRACTOR SHALL VERIFY ALL EXISTING CONDITIONS PRIOR TO STARTING ANY WORK. HE/SHE SHALL NOTIFY THE DESIGNER OF ANY DISCREPANCIES BETWEEN THE CONTRACT DOCUMENTS AND ACTUAL SITE CONDITIONS FOUND DURING OR PRIOR TO DEMOLITION.
- FOUNDATION DESIGN IS BASED ON 2000 PSF STABLE SOIL CONDITIONS.
- PROVIDE TESTING ON SOIL COMPACTION PRIOR TO LAYING STEEL OR POURING CONCRETE. COMPACTION SHOULD ACHIEVE 95% MODIFIED PROCTOR DENSITY.
- PROVIDE ADEQUATE BLOCKING BEHIND ALL WALL MOUNTED FIXTURES
- PROVIDE ALL ACCESSORIES, HARDWARE AND MISC. ITEMS AS PER DRAWINGS AND SPECIFICATIONS. ALL ITEMS SHALL BE INSTALLED AS PER MANUFACTURERS WRITTEN INSTRUCTIONS AND CUT SHEETS.
- CONTRACTOR MUST VERIFY ALL DIMENSIONS PRIOR TO CONSTRUCTION. DO NOT SCALE DRAWINGS.
- ALL CONCRETE SHALL BE 3000 PSI COMPRESSIVE STRENGTH AT 28 DAYS.
- INSTALL DOORS AND WINDOWS PER MANF. DATA PROVIDED W/ PRODUCT. CENTER UNLESS NOTED
- REFER TO WIND LOAD ANALYSIS FOR NAIL PATTERN AND SCHEDULE AND HOLD DOWN TABLES
- ATTIC OVER CONDITIONED SPACE IS UNVENTED. ATTIC INSULATION FOAM-IN-PLACE SPRAY FOAM
- ATTIC OVER PORCHES IS VENTED. THE TOTAL NET FREE VENTILATING AREA SHALL NOT BE LESS THAN 1/150 OF THE AREA OF THE SPACE VENTILATED. VENTILATION OPENINGS HAVING A LEAST DIMENSION LARGER THAN 1/4 INCH (6.4 MM) SHALL BE PROVIDED WITH CORROSION-RESISTANT WIRE CLOTH SCREENING, HARDWARE CLOTH, OR SIMILAR MATERIAL WITH OPENINGS HAVING A LEAST DIMENSION OF 1/16 INCH (1.6 MM) MINIMUM AND 1/4 INCH (6.4 MM) MAXIMUM.
- ALL FLASHING TO MEET CODES. FOLLOW MANUFACTURER'S DATA SHEET AND SMACNA STANDARDS.
- STRUCTURAL CONNECTORS LISTED ARE FOR EXAMPLE. OTHER PRODUCTS MAY BE SUBSTITUTED FOR ANY CONNECTORS LISTED PROVIDED THEY MEET THE REQUIRED LOAD CAPACITIES. FOLLOW MANUFACTURER'S INSTALLATION DATA. ANY CONNECTORS EXPOSED TO THE WEATHER SHALL BE HOT DIPPED GALVANIZED.
- ANCHOR BOLT MINIMUM EMBEDMENT IS 7" UNLESS OTHERWISE NOTED.
- ELECTRICAL INFORMATION IS DIAGRAMMATIC ONLY.
- ALL FIXTURES AND EQUIPMENT MUST MEET THE OWNER'S APPROVAL PRIOR TO PURCHASE AND INSTALLATION
- ALL WOOD IN CONTACT WITH MASONRY OR CONCRETE SHALL BE PRESSURE TREATED. ALL STRUCTURAL WOOD EXPOSED TO WEATHER SHALL BE PRESSURE TREATED.
- ALL WOOD AND WOOD CONSTRUCTION SHALL COMPLY WITH THE RELEVANT CODES AND SPECIFICATIONS AND THE 'AMERICAN INSTITUTE OF TIMBER CONSTRUCTION' (STANDARD MANUAL)
- APPLICATION OF PAINT OR OTHER COATING SHALL BE IN STRICT ACCORDANCE WITH THE MANUFACTURER'S DIRECTIONS. READY-MIXED PAINT SHALL NOT BE THINNED, EXCEPT AS PERMITTED IN THE APPLICATION INSTRUCTIONS.
- ALL SURFACES TO BE FINISHED SHALL BE CLEAN AND FREE OF FOREIGN MATERIALS, (DIRT, GREASE, ASPHALT, RUST, ETC.)
- APPLICATION SHALL BE IN A WORKMANLIKE MANNER PROVIDING A SMOOTH SURFACE. APPLICATION RATE SHALL BE THAT RECOMMENDED BY THE MANUFACTURER. APPLICATION MAY BE BY BRUSH OR ROLLER, OR MAY BE BY SPRAY IF PAINT IS FORMULATED FOR SAME.
- PROVIDE EXTERIOR AND INTERIOR SURFACE FINISHES AS SCHEDULED, AS APPROPRIATE FOR THEIR LOCATION OR EXPOSURE TO WEATHER, AND AS RECOMMENDED BY THE MANUFACTURER.
- OTHER FINISHES AS PER CONSTRUCTION DOCUMENTS, FINISH SCHEDULE OR OWNER'S SPECIFICATIONS.
- THE DESIGNER SHALL NOT BE RESPONSIBLE FOR AND WILL NOT HAVE CONTROL OR CHARGE OF CONSTRUCTION MEANS, METHODS, TECHNIQUES, SEQUENCES OR PROCEDURES. NOR WILL HE/SHE B RESPONSIBLE FOR THE SAFETY PRECAUTIONS AND PROGRAMS IN CONNECTION WITH THE WORK, OR THE CONTRACTOR'S FAILURE TO CARRY OUT THE WORK IN ACCORDANCE WITH THE CONTRACT DOCUMENTS THE DESIGNER SHALL NOT BE RESPONSIBLE FOR OR HAVE CONTROL OR CHARGE OVER THE ACTS OR OMISSIONS OF THE CONTRACTOR, SUB-CONTRACTORS, OR ANY OF THEIR AGENTS OR EMPLOYEES, OR ANY OTHER PERSONS PERFORMING ANY OF THE WORK.

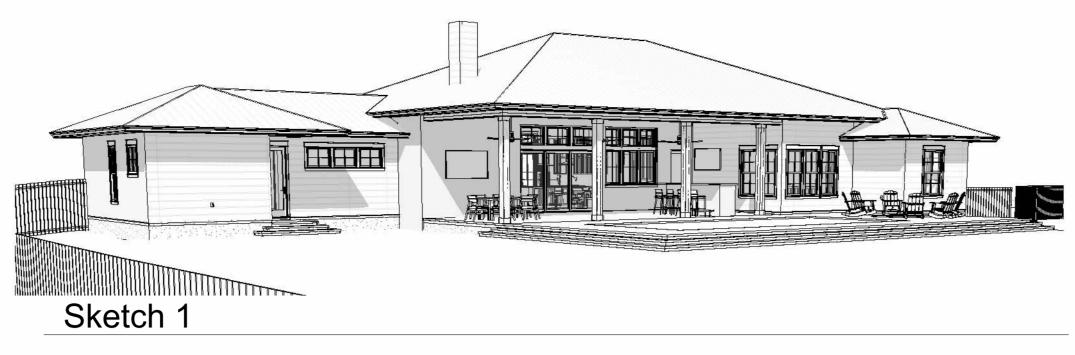




Area Schedule (Gross Building)		
Area	Name	
Conditioned		
2973 SF	Conditioned	
2973 SF		
Open Deck		
1532 SF	Pool Deck	
1532 SF	'	

Unconditioned	
647 SF	Garage
743 SF	Rear Rorch
157 SF	Front Porch
1547 SF	

6051 SF

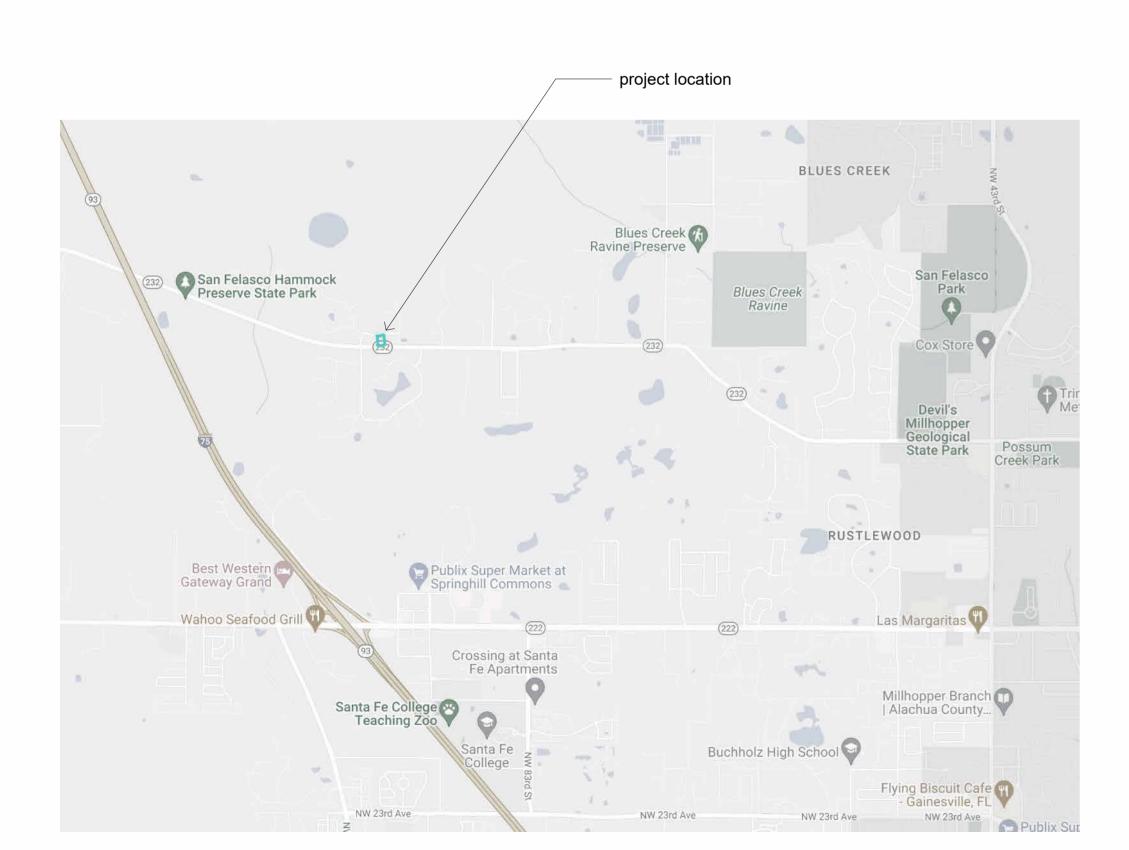





Project Identification McFall Residence

Project Location 9515 NW 62nd Lane Gainesville, Florida 32653

<u>Owner</u>

Jason & Ashley McFall


<u>Designer</u>


Bob Harris - dba Bob Harris Design 2351 SW 56th Avenue Gainesville, Florida 32608

Sheet List					
Sheet Number	Sheet Name				
A0	Cover				
A1	Floor Plan - House				
A2	Floor Plan - Pool Deck				
A3	Elevations				
A4	Elevations				
A5	Slab Plan				
A6	Roof Plan				
A7	Details				
A8	Details				
A9	Electrical Plan				

Project Scope

- New Home
- 2 Story
- Wood Framed Construction Concrete Slab on Masonry Stem Wall

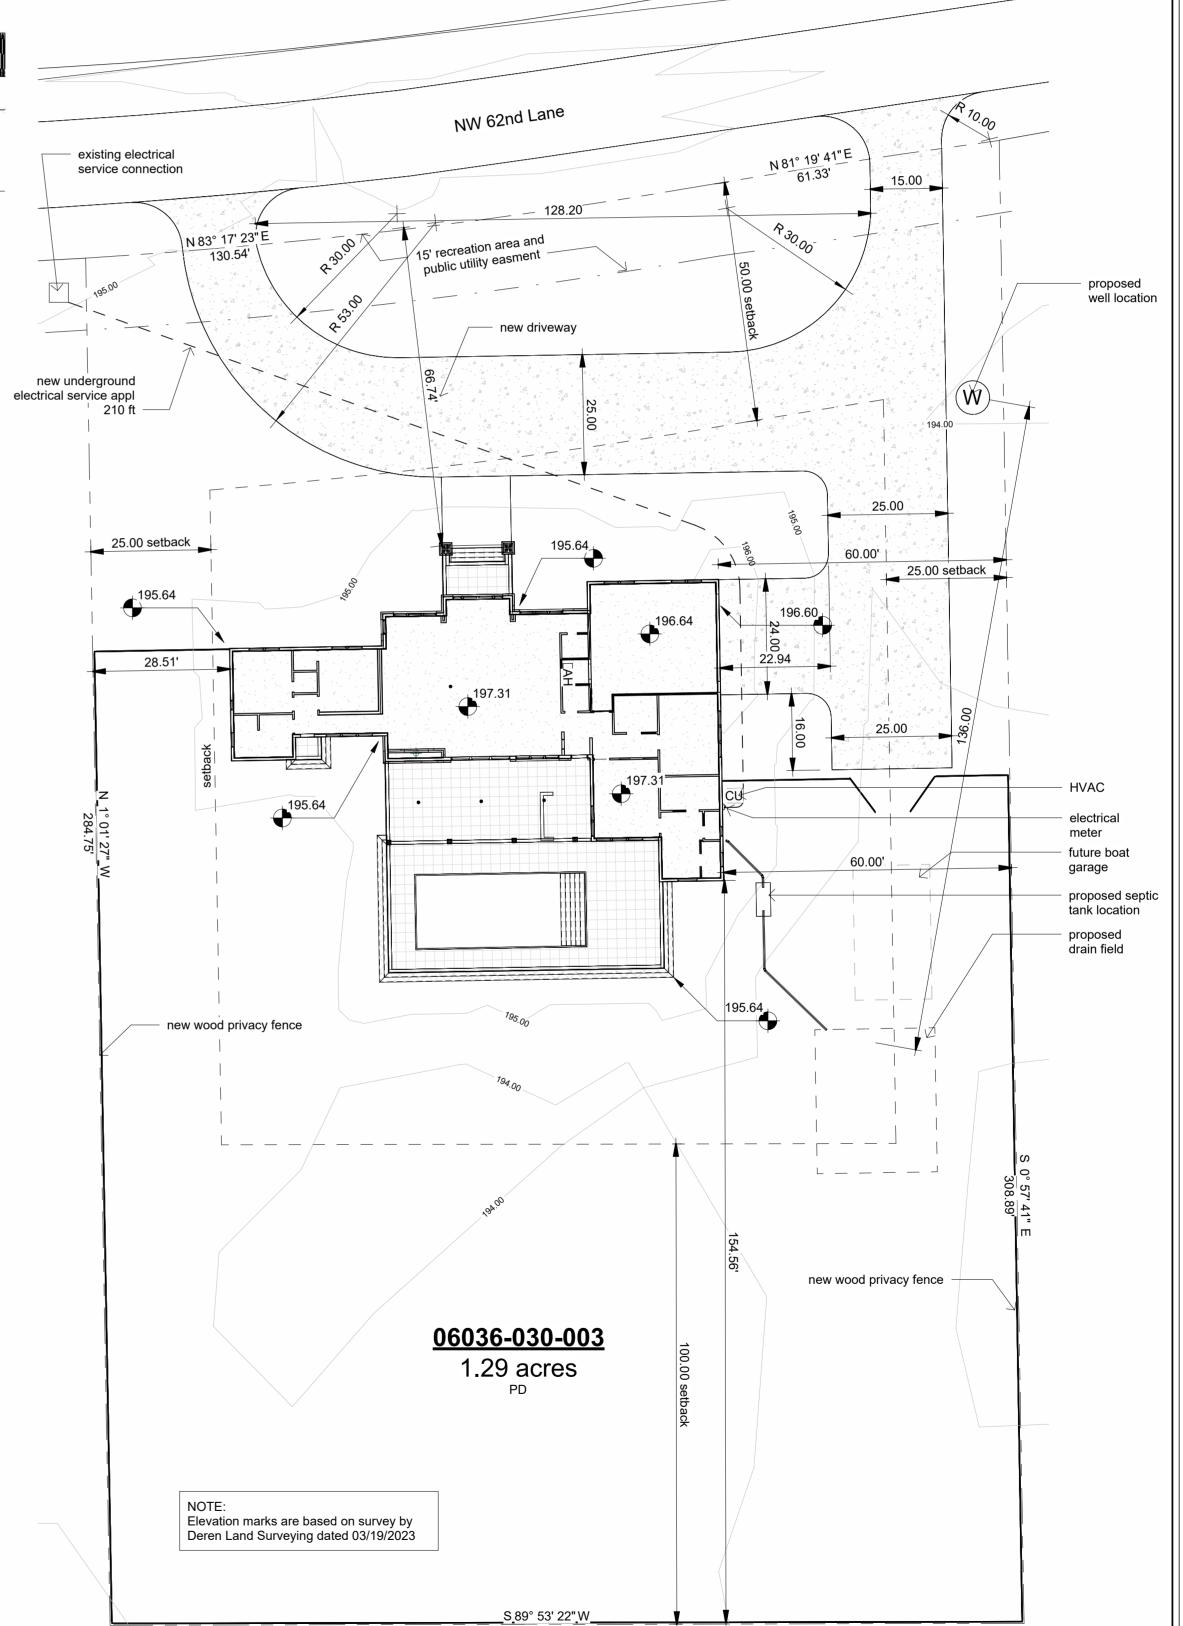

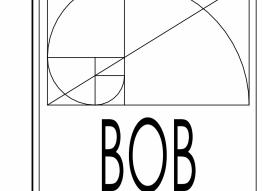

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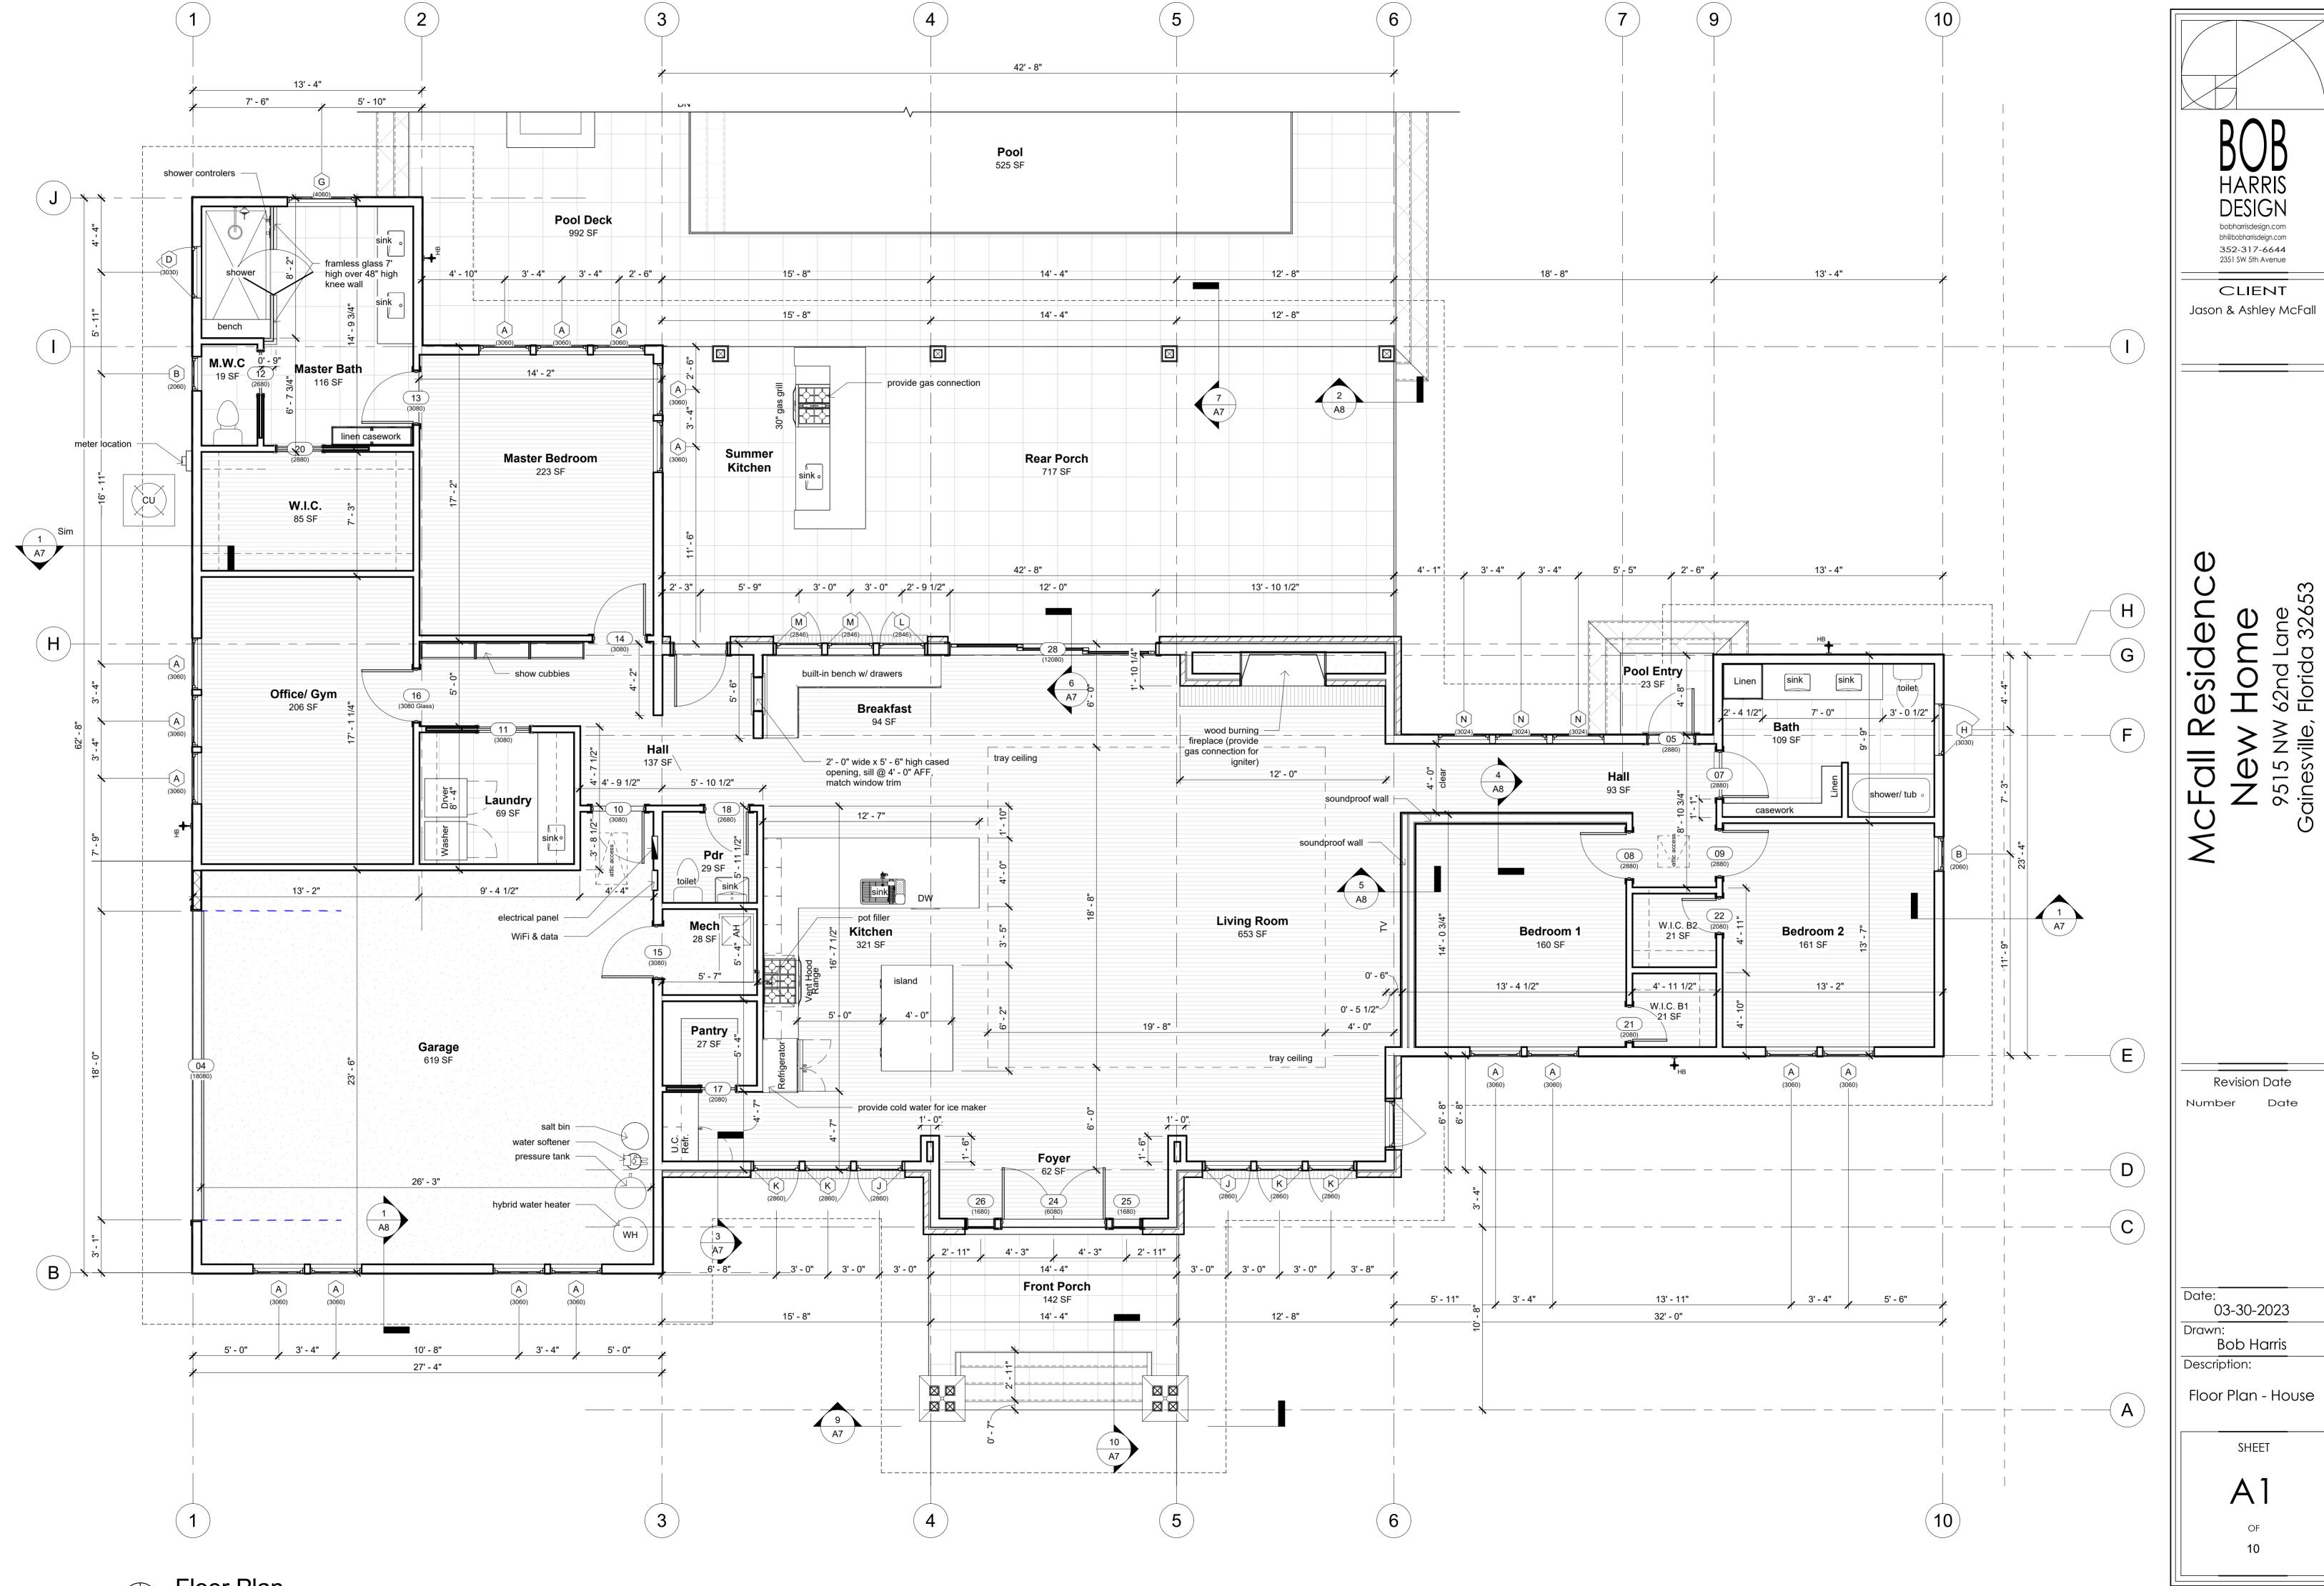
Jason & Ashley McFall

Revision Date Number

Date: 03-30-2023 Drawn:


Bob Harris Description: Cover

SHEET




Floor Plan

1/4" = 1'-0"

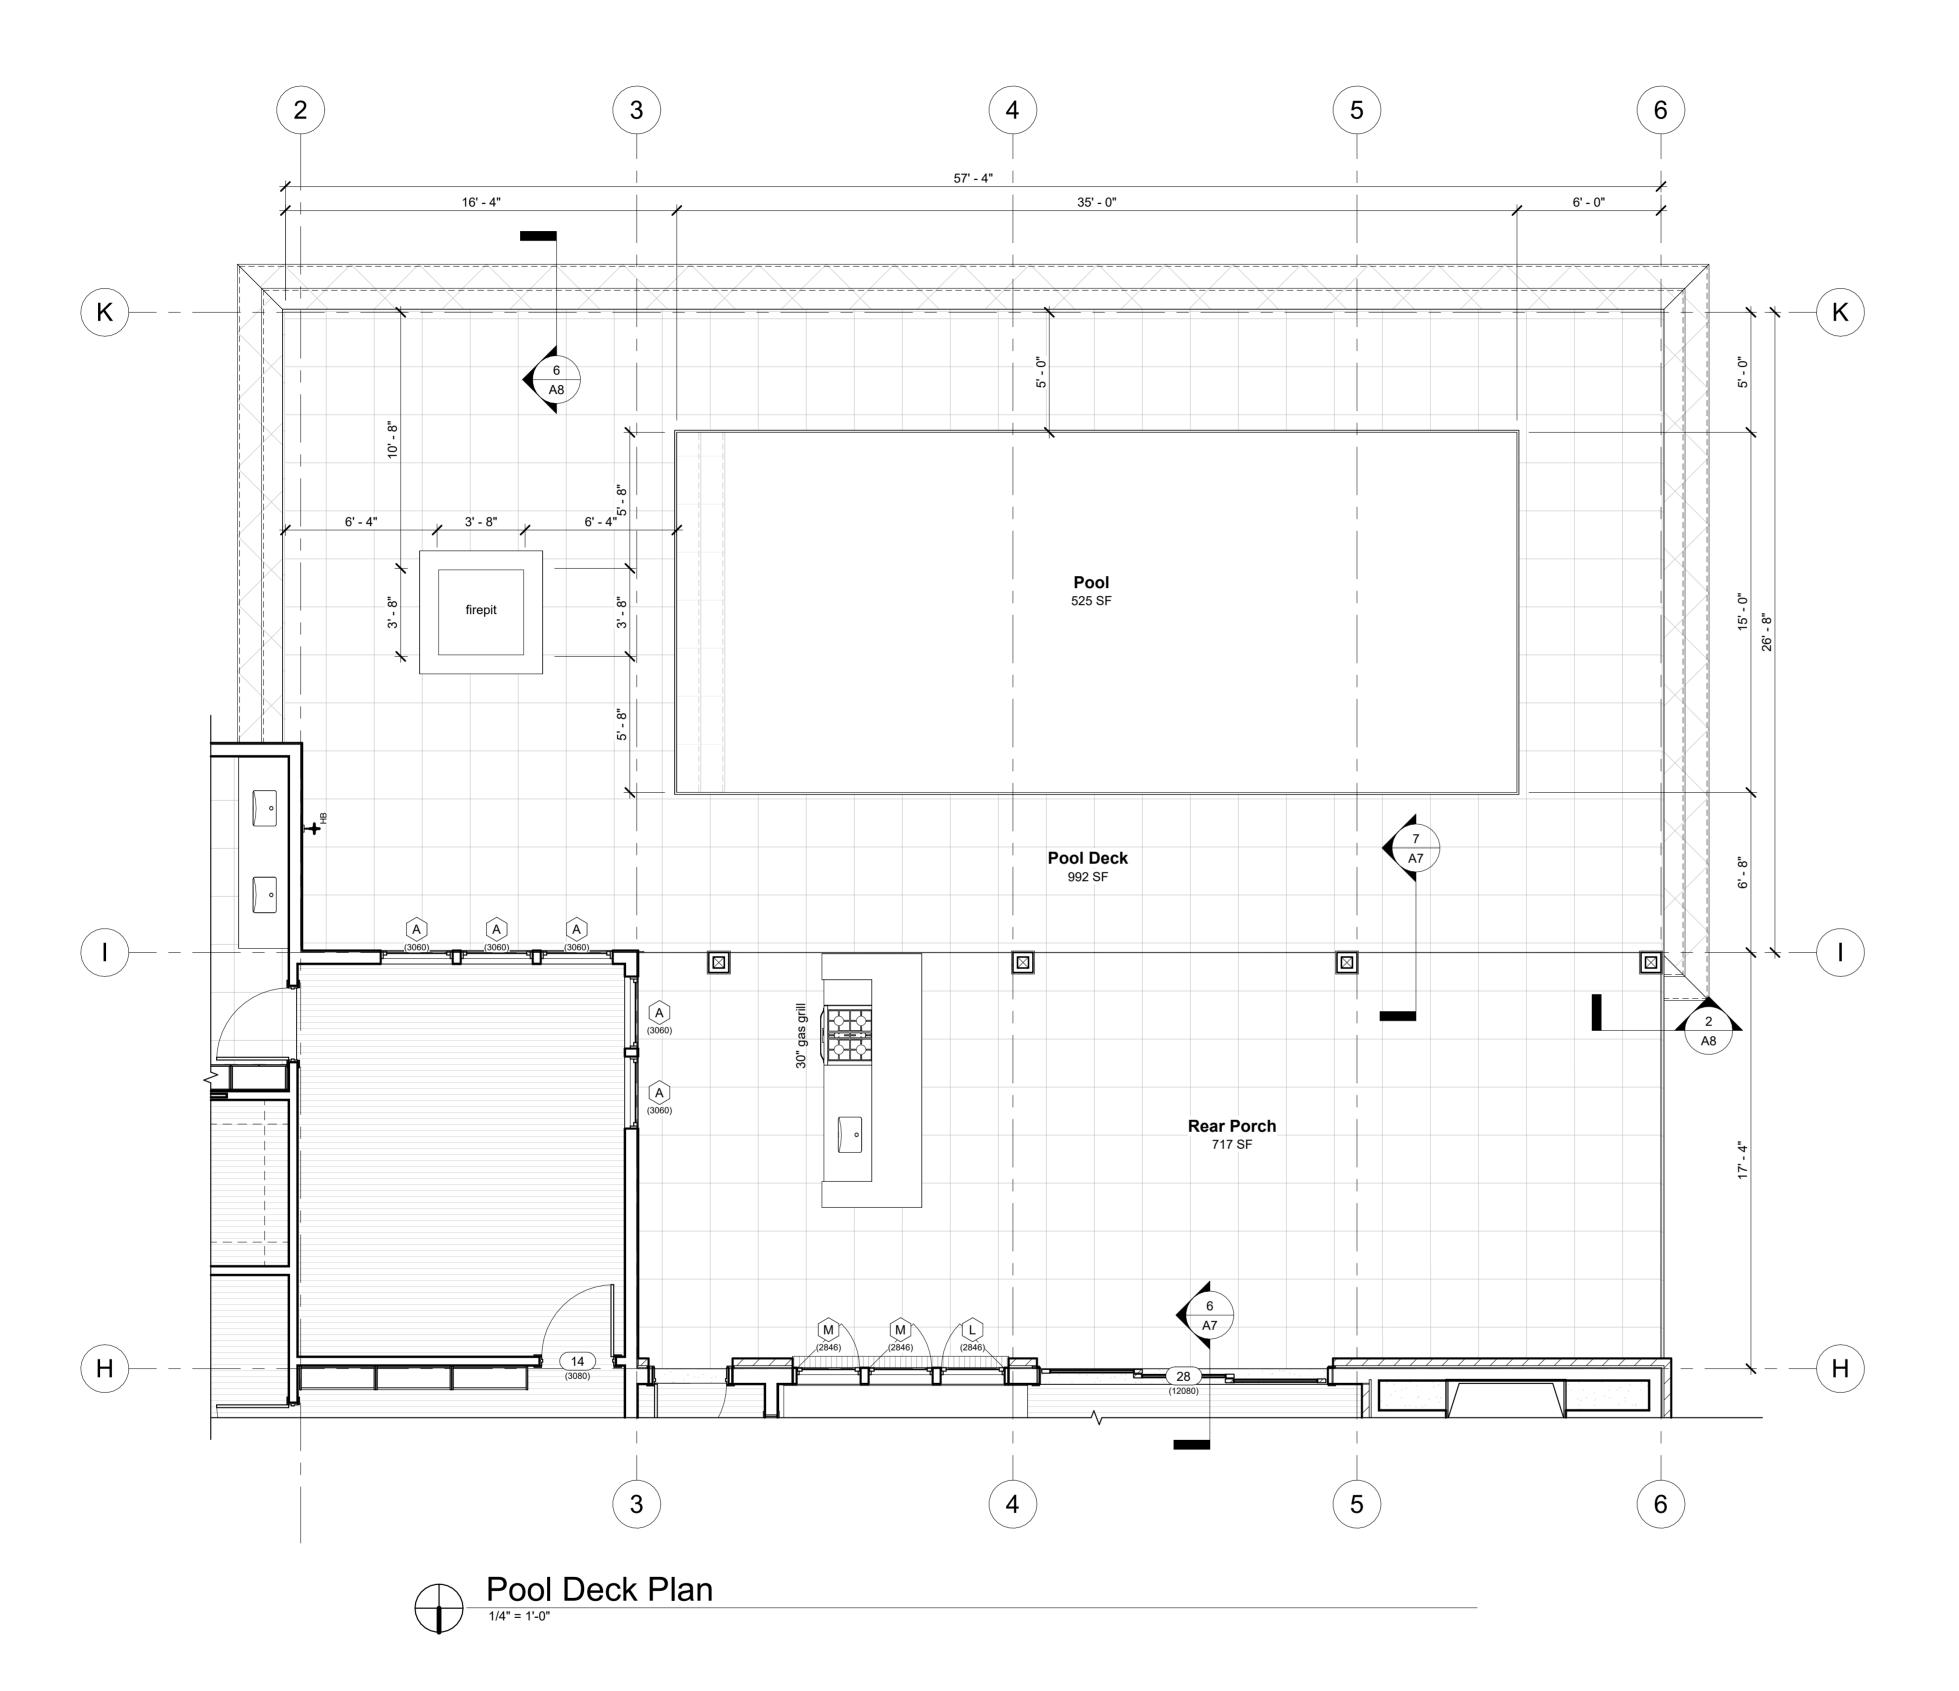

	Door Schedule					
Mark	Width	Height	Location	Description	Comments	
24	6' - 0"	8' - 0"	Foyer	(2) Full Light	Main Entry Door	
25	1' - 6"	8' - 0"	Front Porch	Entry Sidelight		
26	1' - 6"	8' - 0"	Front Porch	Entry Sidelight		
04	18' - 0"	8' - 0"	Garage	Garage Door		
05	2' - 8"	8' - 0"	Pool Entry	Full Light		
29	3' - 0"	8' - 0"	Rear Porch	Full Light		
07	2' - 8"	8' - 0"	Bath			
08	2' - 8"	8' - 0"	Bedroom 1			
09	2' - 8"	8' - 0"	Bedroom 2			
10	3' - 0"	8' - 0"	Garage			
11	3' - 0"	8' - 0"	Laundry	Full Light Obscured, Pocket Door		
12	2' - 6"	8' - 0"	M.W.C	Pocket Door		
13	3' - 0"	8' - 0"	Master Bath			
14	3' - 0"	8' - 0"	Master Bedroom			
15	3' - 0"	8' - 0"	Mech			
16	3' - 0"	8' - 0"	Office/ Gym	Full Light Obscured		
17	2' - 0"	8' - 0"	Pantry	Full Light Obscured, Pocket Door		
18	2' - 6"	8' - 0"	Pdr			
28	12' - 0"	8' - 0"	Rear Porch	(3) Panel (3) Track Sliding Glass Doors		
20	2' - 8"	8' - 0"	W.I.C.	Full Light Obscured, Pocket Door		
21	2' - 0"	8' - 0"	W.I.C. B1			
22	2' - 0"	8' - 0"	W.I.C. B2			

	Window Schedule									
Type Mark	Width	Height	Description	Comments	Head Height	Count				
Α	3' - 0"	6' - 0"	Single Hung		8' - 0"	16				
В	2' - 0"	6' - 0"	Single Hung		8' - 0"	2				
С	3' - 9"	2' - 4"	Fixed Glass, Transom		10' - 10"	3				
D	3' - 0"	3' - 0"	Casement, Right Hinge		8' - 0"	1				
E	2' - 10"	2' - 4"	Fixed Glass, Transom		10' - 10"	2				
F	1' - 6"	2' - 4"	Fixed Glass, Transom		10' - 10"	2				
G	4' - 0"	6' - 0"	Single Hung		8' - 0"	1				
Н	3' - 0"	3' - 0"	Casement, Left Hinge		8' - 0"	1				
I	2' - 8"	2' - 4"	Fixed Glass, Transom		10' - 10"	9				
J	2' - 8"	6' - 0"	Casement, Left Hinge		8' - 0"	2				
K	2' - 8"	6' - 0"	Casement, Right Hinge		8' - 0"	5				
L	2' - 8"	4' - 6"	Casement, Left Hinge		8' - 0"	1				
М	2' - 8"	4' - 6"	Casement, Right Hinge		8' - 0"	2				
N	3' - 0"	2' - 4"	Fixed Glass		8' - 0"	3				

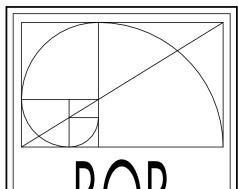

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McFall Residence New Home

Revision Date

Number Date

Date: 03-30-2023


Drawn: Bob Harris


Description:

Floor Plan - Pool Deck

SHEE

A2

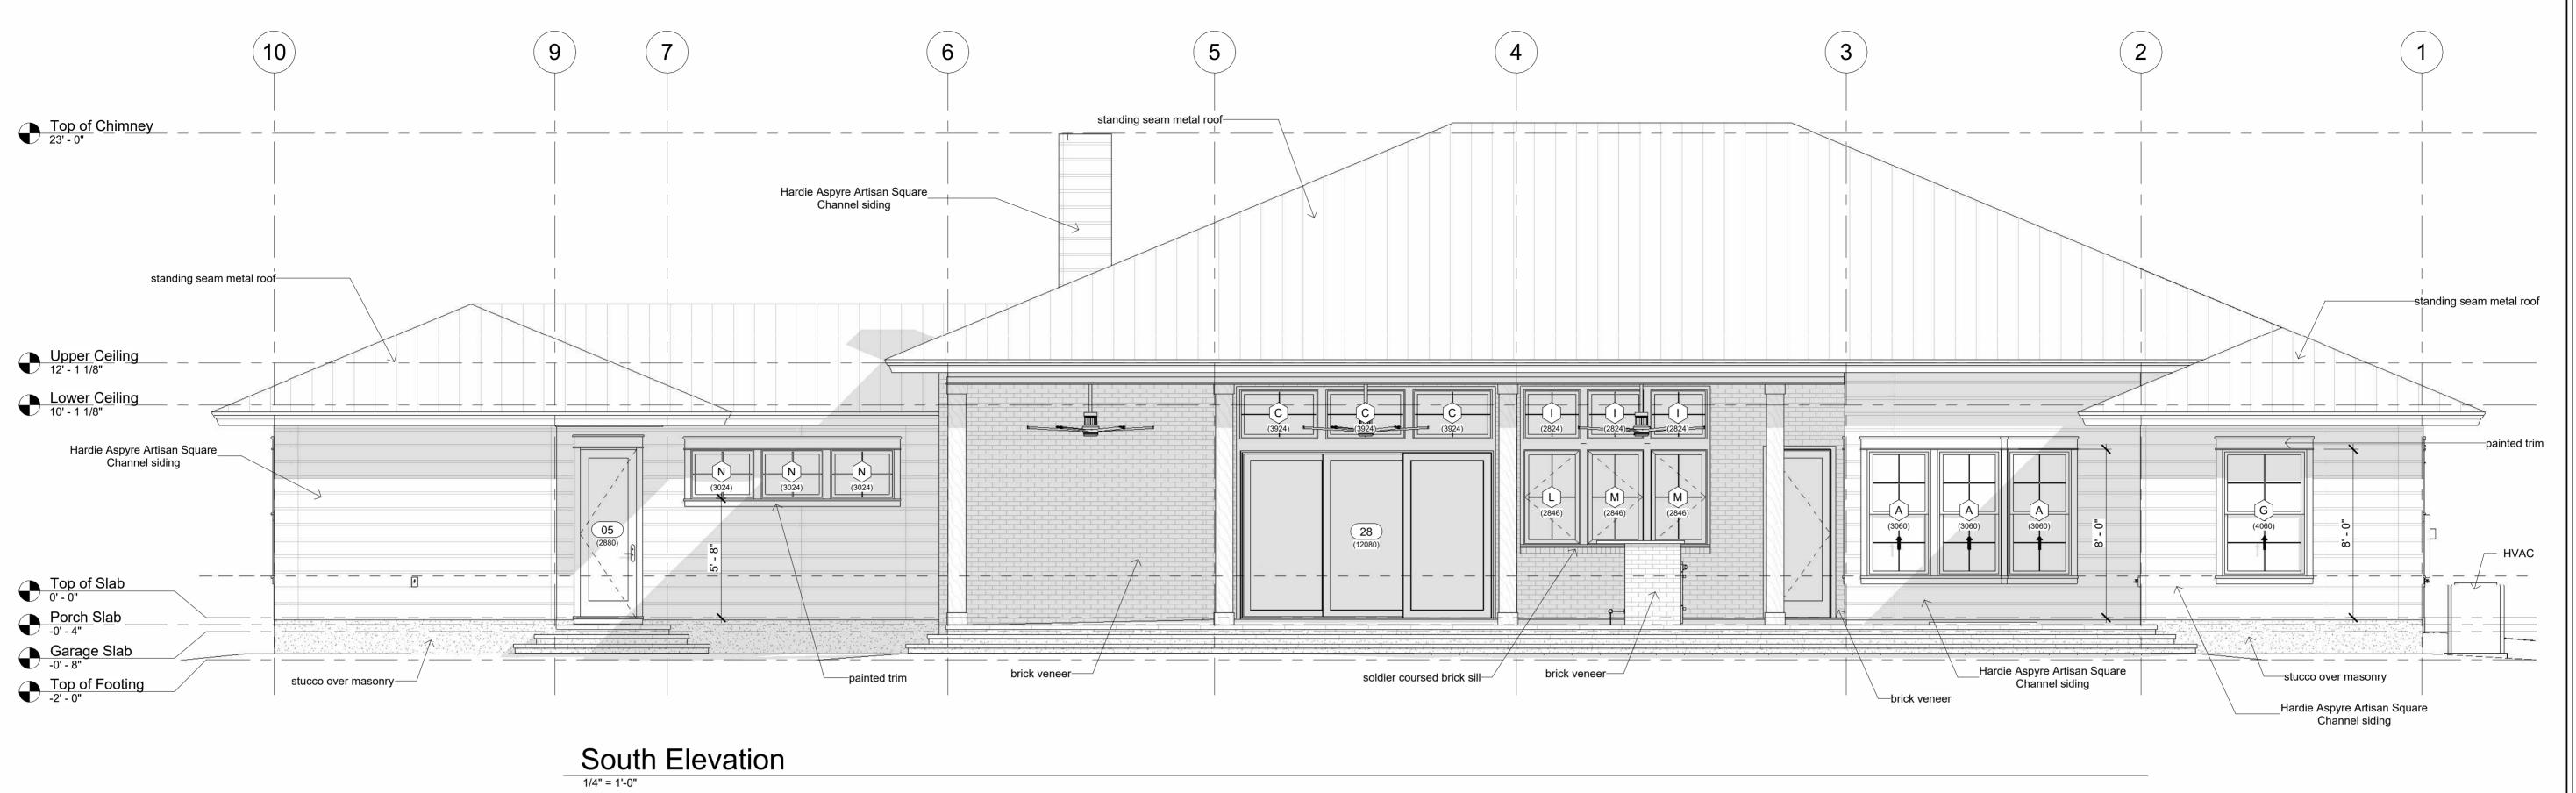

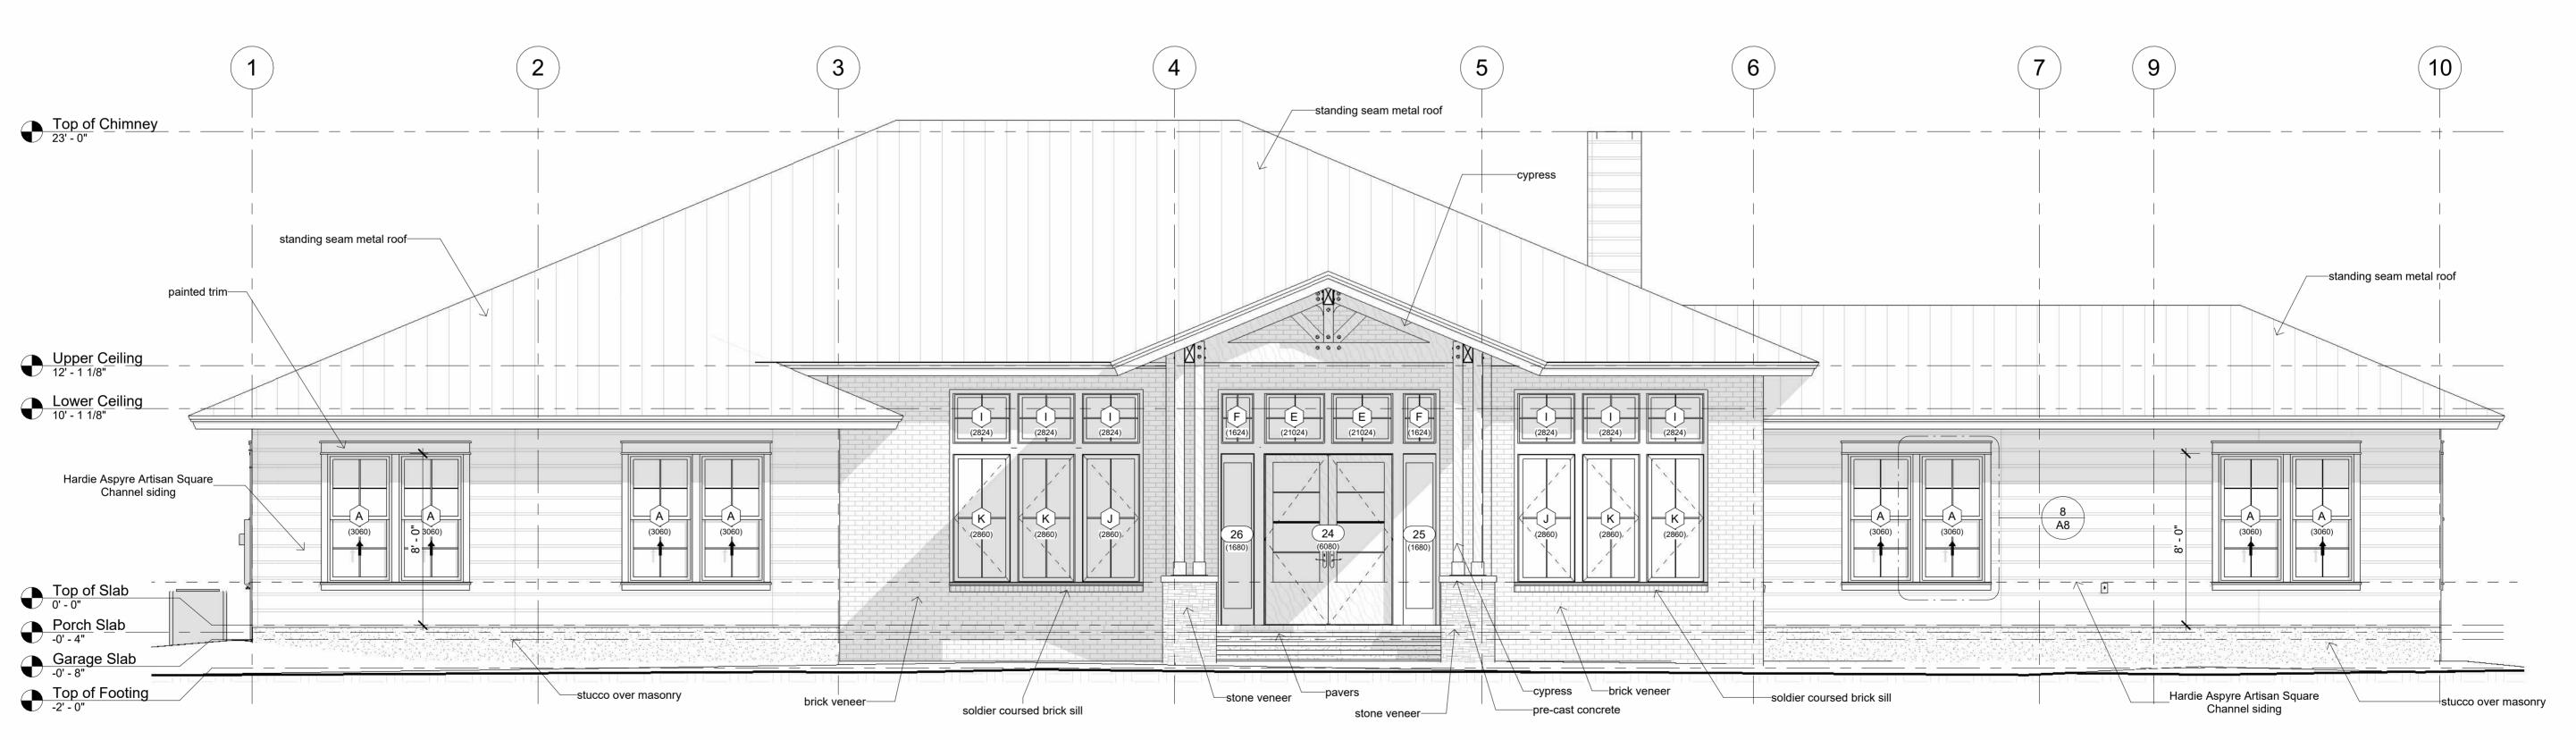

North Elevation

1/4" = 1'-0"


esiden **Revision Date** Number Date Date: 03-30-2023 Drawn: **Bob Harris** Description: Elevations SHEET

DESIGN


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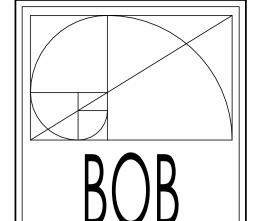
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Jason & Ashley McFall





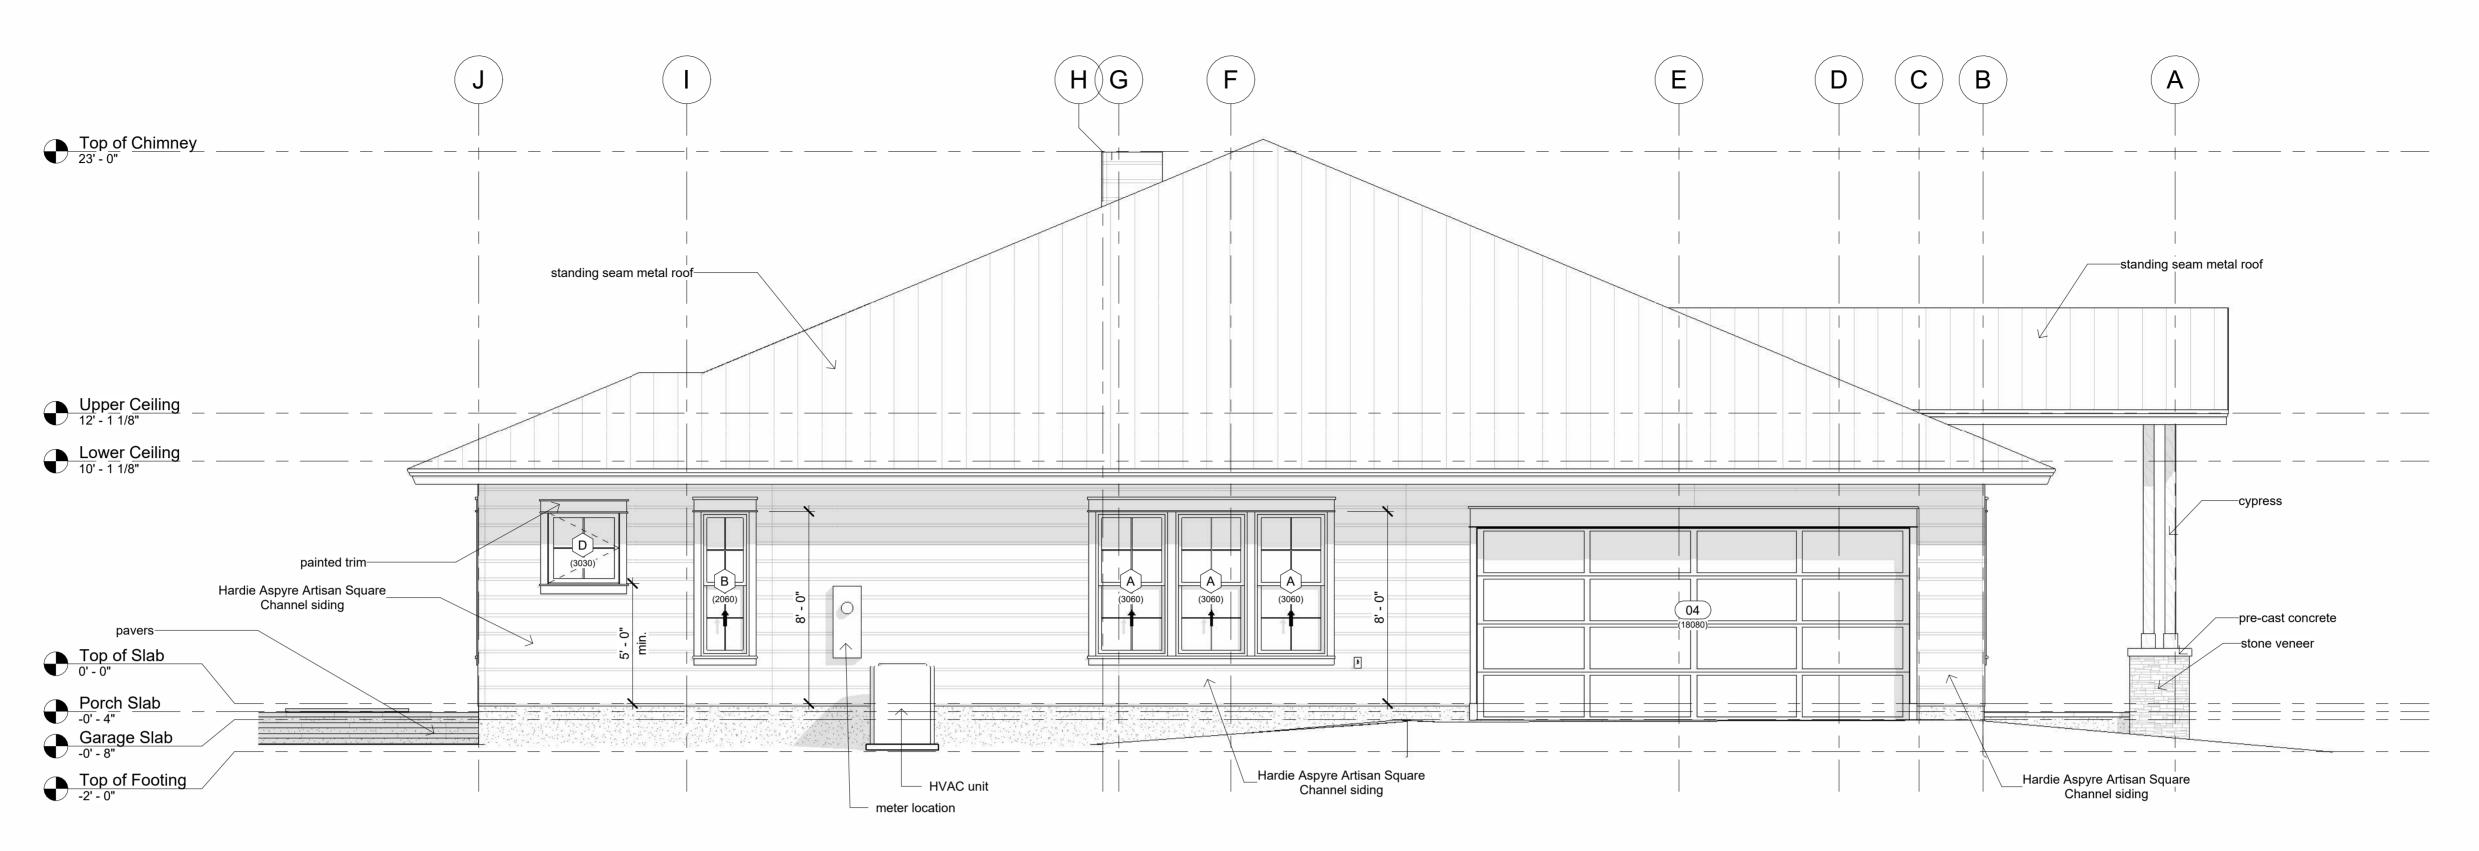

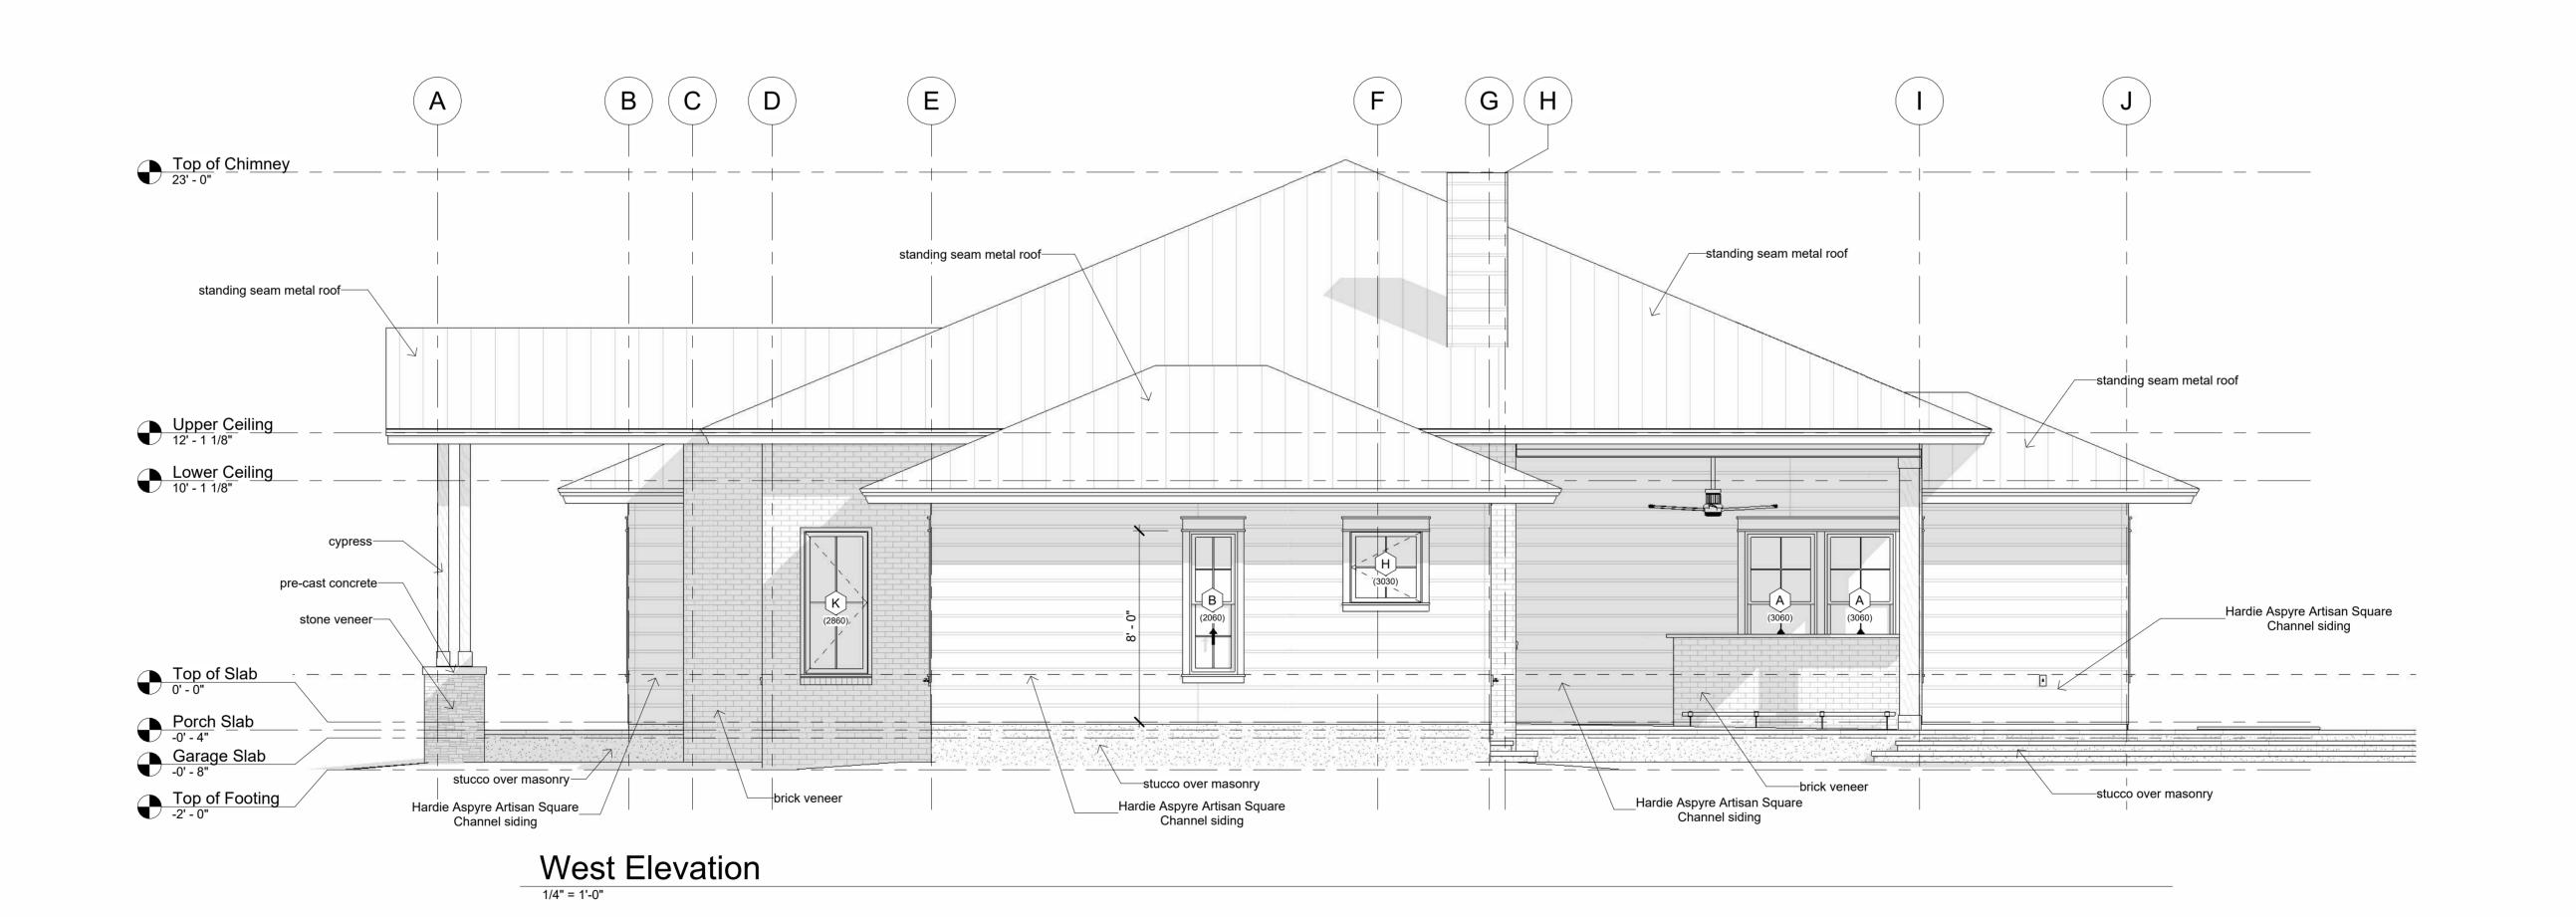

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Jason & Ashley McFall

McFall Residence
New Home
9515 NW 62nd Lane
Gainesville, Florida 32653

Revision Date

Number Date

Date: 03-30-2023

Drawn:


Bob Harris


Description:

Elevations

SHEET

A4

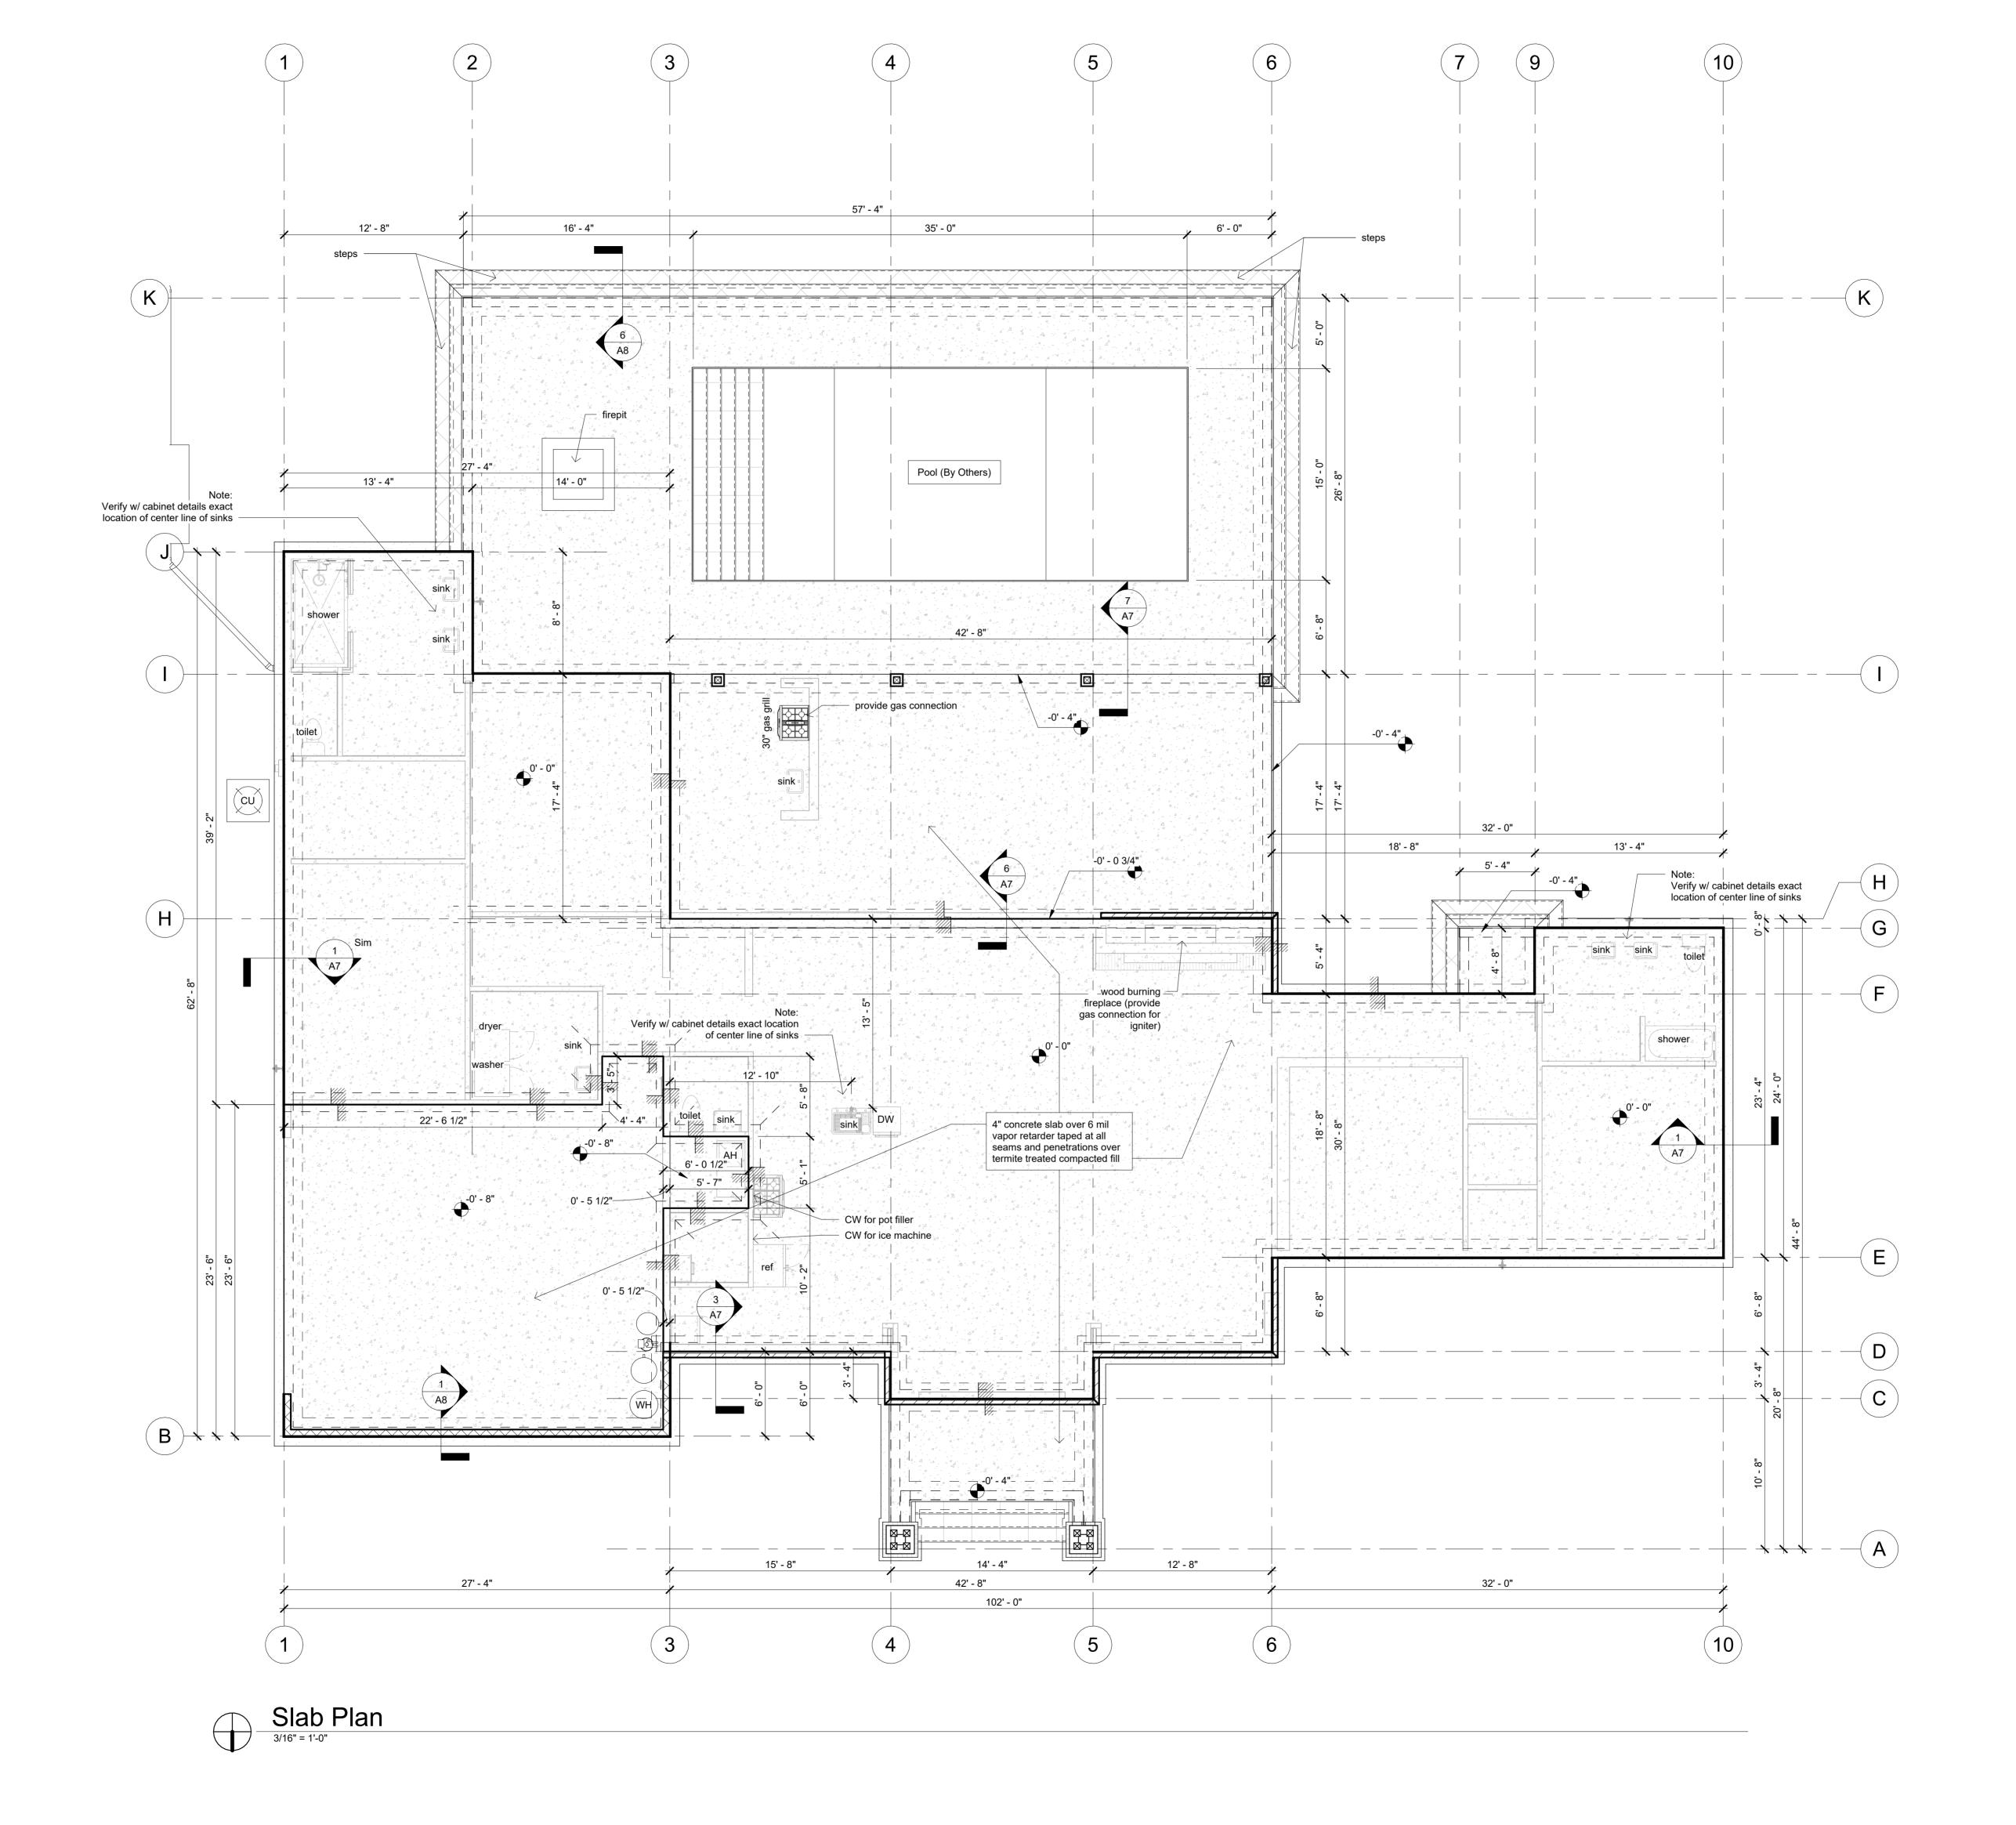

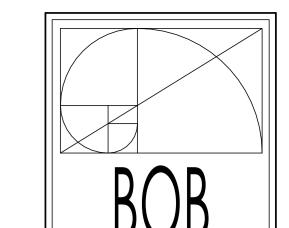

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AcFall Residence
New Home

Revision Date

Number Date


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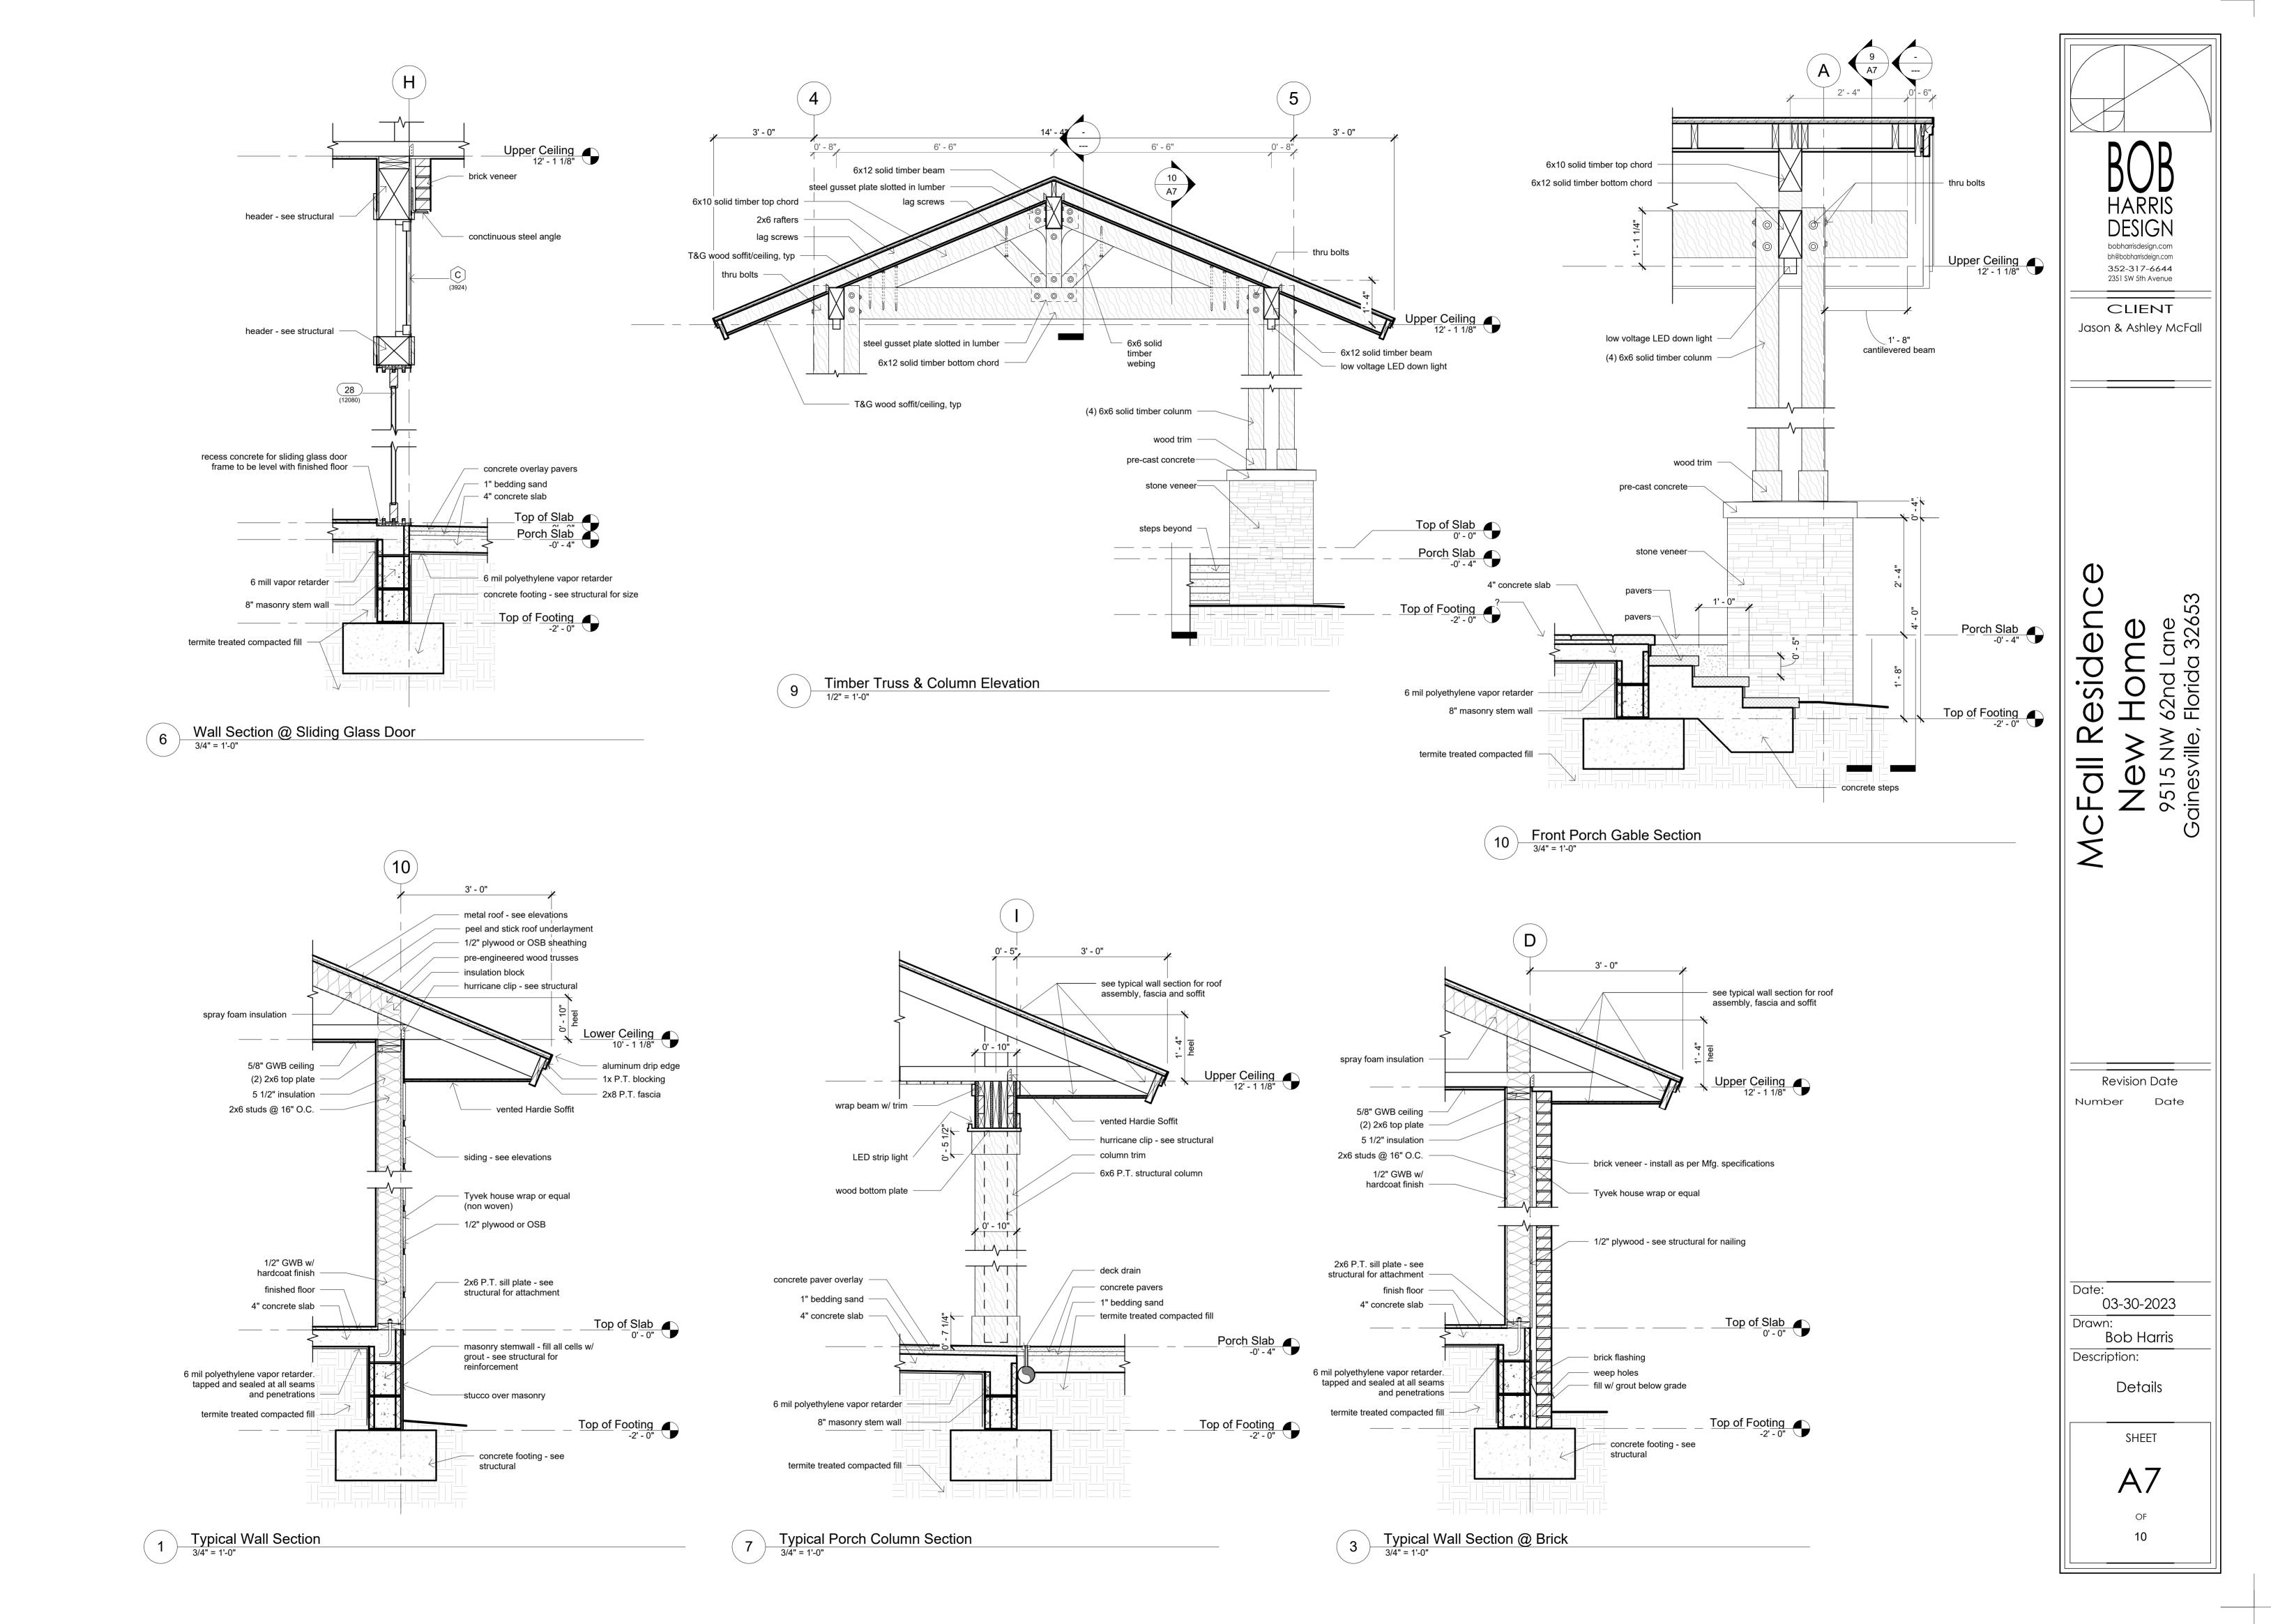
Drawn:
Bob Harris
Description:


Slab Plan

SHEET


A5



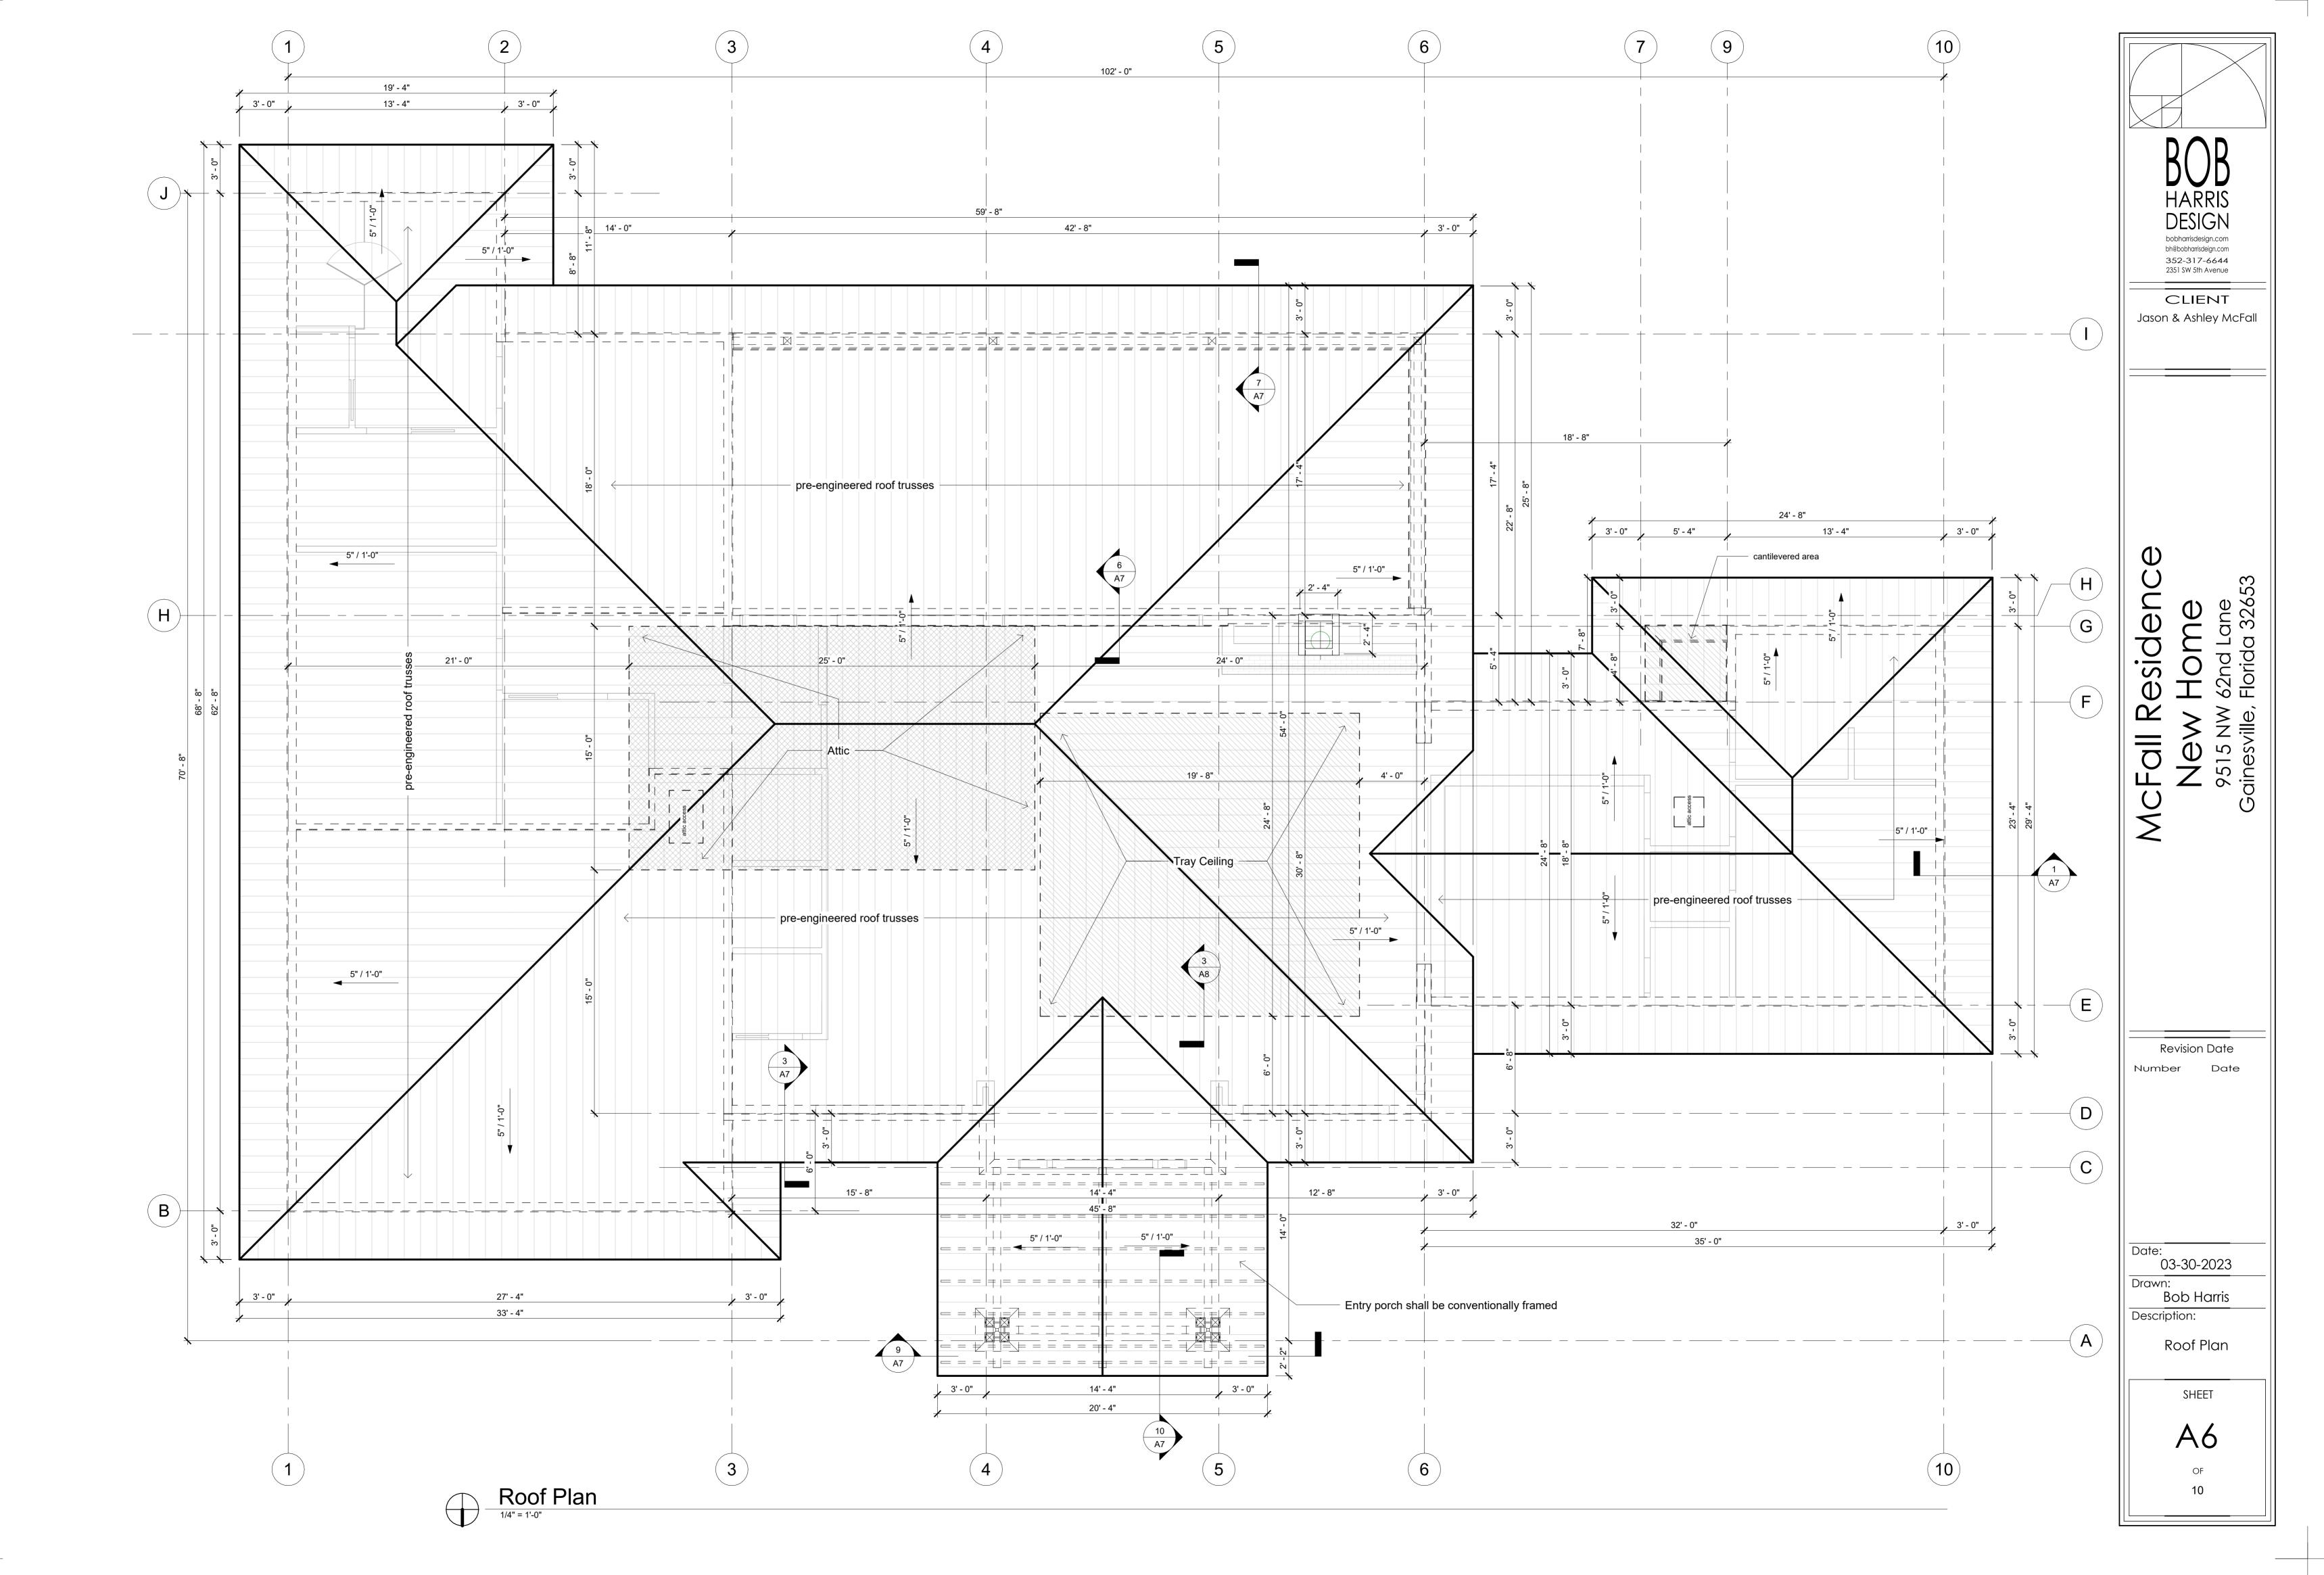


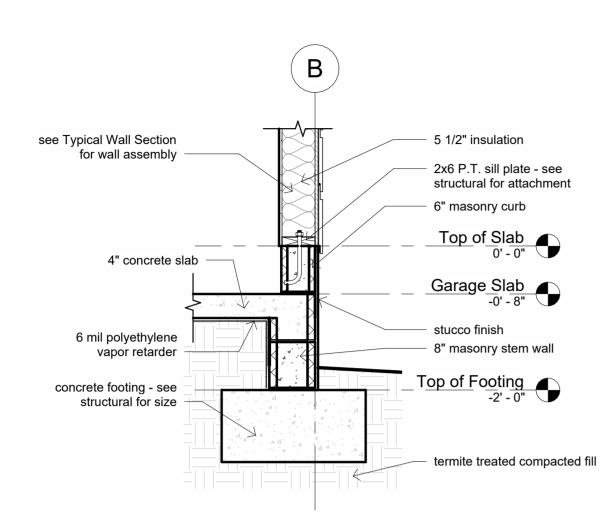


Stem Wall Detail @ Garage

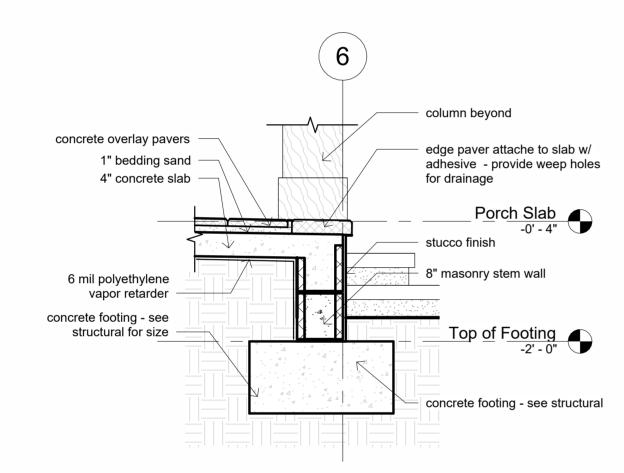


Stem Wall Detail @ Porch

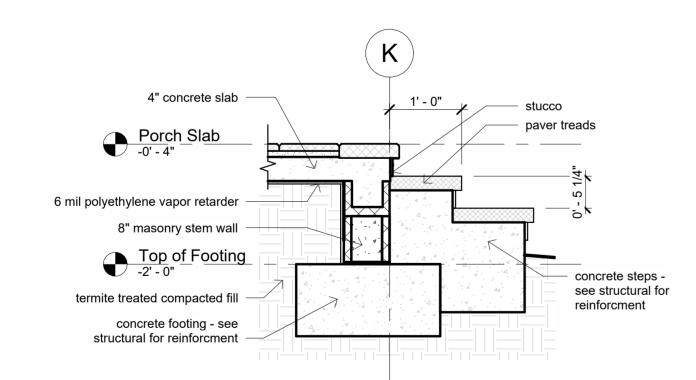


Pool Deck Step Detail
3/4" = 1'-0"

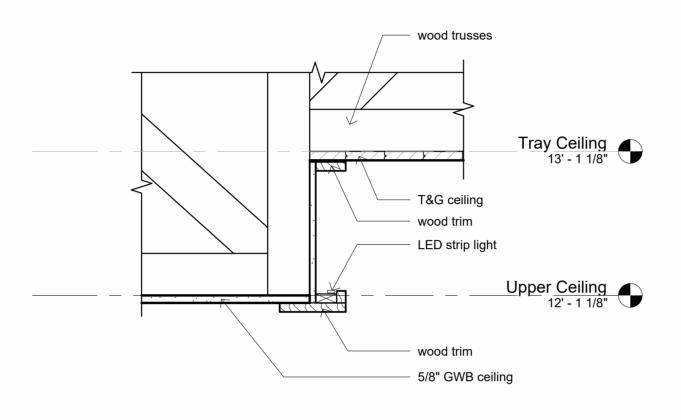

3 Tray Ceiling Trim Detail
1 1/2" = 1'-0"

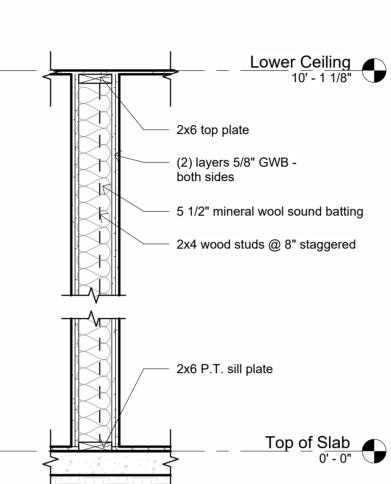

Soundproof Wall @ Hall
3/4" = 1'-0"

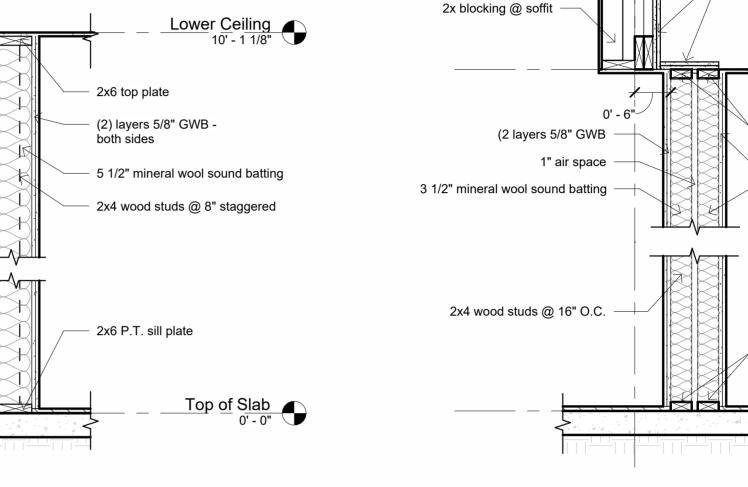

metal Z flashing, typ. all windows

5/4 cornice

- 5/4 x 5.5" frieze

4/4 architrave

— 5/4 x 3.5" legs

5/4 mulls


5/4 sill sloped for drainage

Typical Exterior Window Trim
1/2" = 1'-0"

All trim members shall be Hardie Trim

Typical Interior Window Trim
1/2" = 1'-0"

Soundproof Wall @ TV

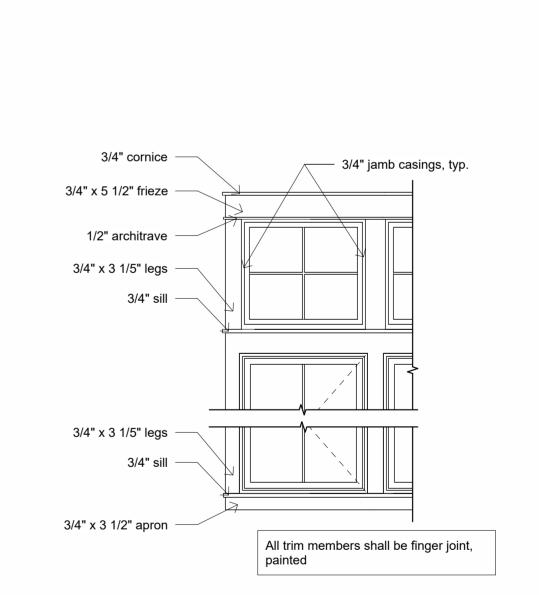

6

girder truss

Upper Ceiling 12' - 1 1/8"

- (2) layers 5/8" GWB to bottom of

Lower Ceiling 10' - 1 1/8"

roof deck

3 1/2" mineral wool sound batting

(2) 2x4 top plates

(2 layers 5/8" GWB

— (2) 2x4 P.T. bottom plates

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Jason & Ashley McFall

esidenc

Revision Date

Date


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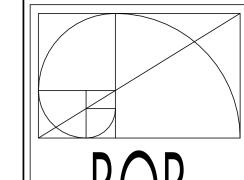
Date:

03-30-2023 Drawn: **Bob Harris** Description:

Details

SHEET



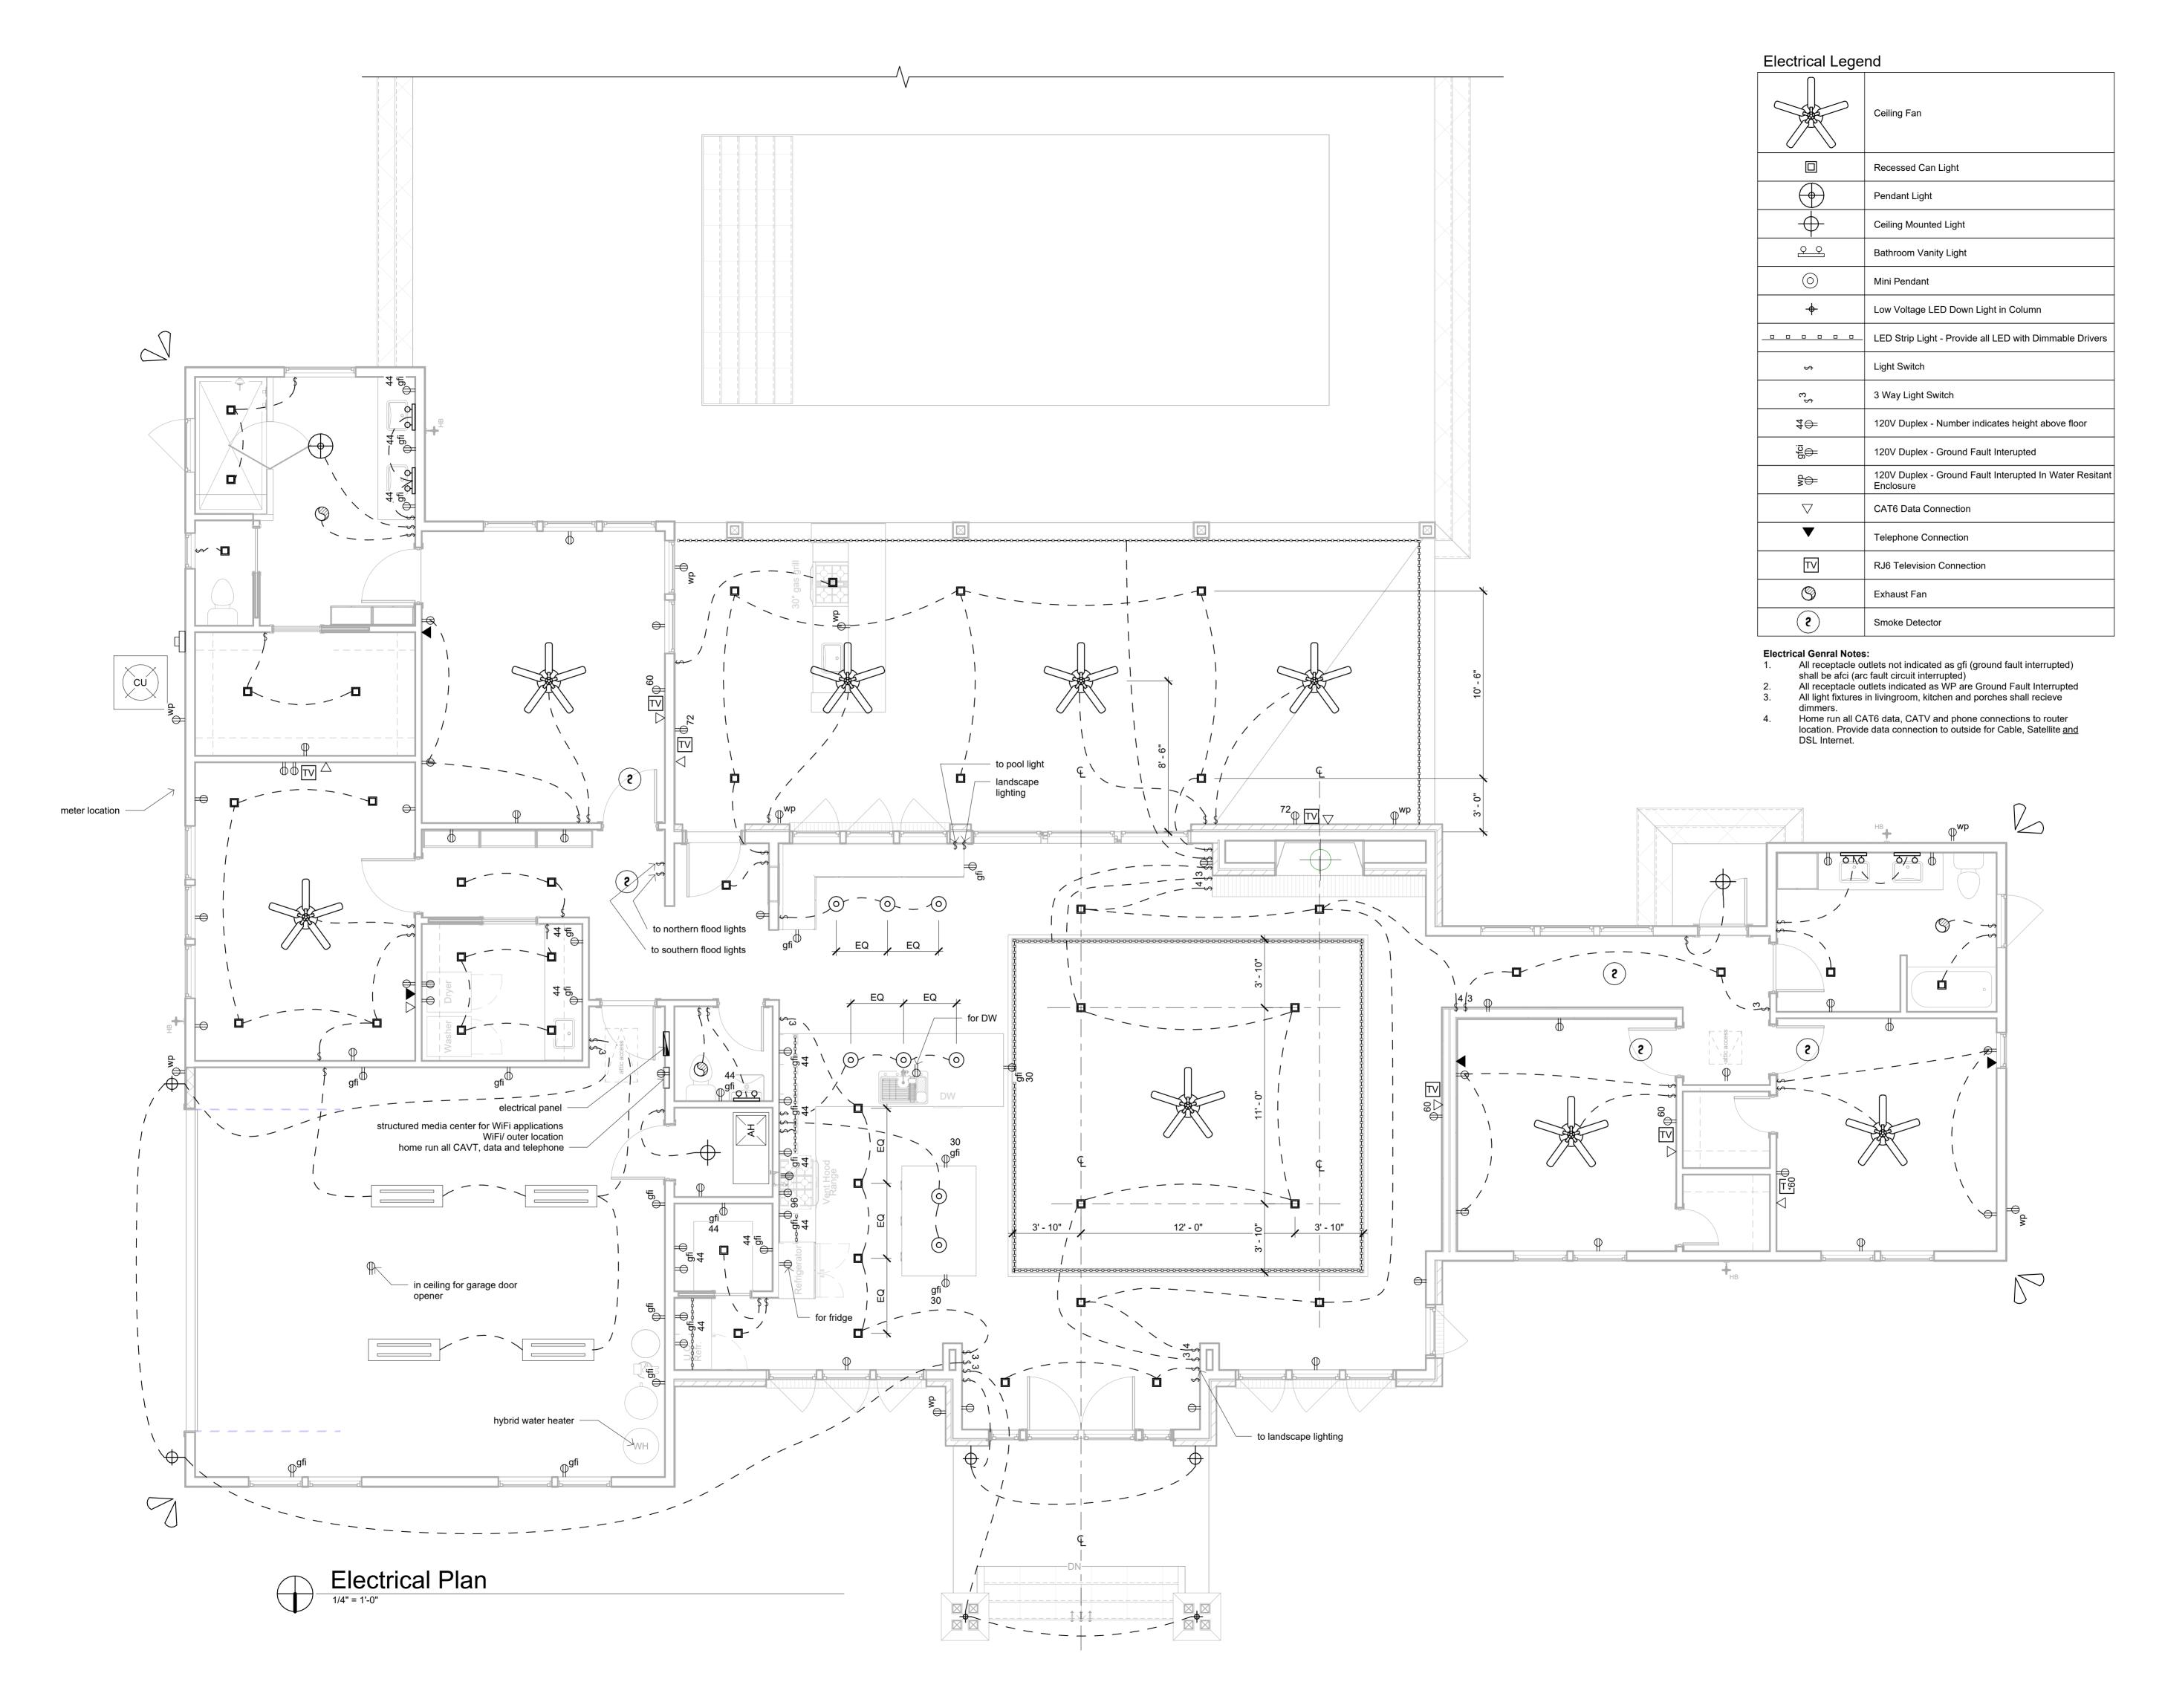

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all Residence ew Home

Revision Date

Number Date

re: 03-30-2023

Drawn:

Bob Harris

Description:

Electrical Plan

SHEE

A9