



General Notes:


- ALL WORK SHALL CONFORM TO THE LATEST FLORIDA BUILDING CODE, THE NFPA LIFE SAFETY CODE, AND ALL OTHER APPLICABLE CODES AND ORDINANCES. OBTAIN ALL REQUIRED PERMITS FOR THE PROPER LEGAL EXECUTION OF THE WORK DESCRIBED IN THESE DRAWINGS AND SPECIFICATIONS.
- PROVIDE A CONTINUOUS LOAD PATH FROM TRUSSES OR RAFTERS TO FOUNDATION FOR ALL NEW CONSTRUCTION. IF ANY DISCREPANCIES, CALL DESIGNER FOR CLARIFICATION BEFORE PROCEEDING.
- THE CONTRACTOR SHALL VERIFY ALL EXISTING CONDITIONS PRIOR TO STARTING ANY WORK. HE/SHE SHALL NOTIFY THE DESIGNER OF ANY DISCREPANCIES BETWEEN THE CONTRACT DOCUMENTS AND ACTUAL SITE CONDITIONS FOUND DURING OR PRIOR TO DEMOLITION.
- FOUNDATION DESIGN IS BASED ON 2000 PSF STABLE SOIL CONDITIONS.
- PROVIDE TESTING ON SOIL COMPACTION PRIOR TO LAYING STEEL OR POURING CONCRETE. COMPACTION SHOULD ACHIEVE 95% MODIFIED PROCTOR DENSITY.
- PROVIDE ADEQUATE BLOCKING BEHIND ALL WALL MOUNTED FIXTURES
- PROVIDE ALL ACCESSORIES, HARDWARE AND MISC. ITEMS AS PER DRAWINGS AND SPECIFICATIONS. ALL ITEMS SHALL BE INSTALLED AS PER MANUFACTURERS WRITTEN INSTRUCTIONS AND CUT SHEETS.
- CONTRACTOR MUST VERIFY ALL DIMENSIONS PRIOR TO CONSTRUCTION. DO NOT SCALE DRAWINGS.
- ALL CONCRETE SHALL BE 3000 PSI COMPRESSIVE STRENGTH AT 28 DAYS.
- INSTALL DOORS AND WINDOWS PER MANF. DATA PROVIDED W/ PRODUCT. CENTER UNLESS NOTED
- REFER TO WIND LOAD ANALYSIS FOR NAIL PATTERN AND SCHEDULE AND HOLD DOWN TABLES
- ATTIC OVER CONDITIONED SPACE IS UNVENTED. ATTIC INSULATION FOAM-IN-PLACE SPRAY FOAM INSULATION.
- ATTIC OVER PORCHES IS VENTED. THE TOTAL NET FREE VENTILATING AREA SHALL NOT BE LESS THAN 1/150 OF THE AREA OF THE SPACE VENTILATED. VENTILATION OPENINGS HAVING A LEAST DIMENSION LARGER THAN 1/4 INCH (6.4 MM) SHALL BE PROVIDED WITH CORROSION-RESISTANT WIRE CLOTH SCREENING, HARDWARE CLOTH, OR SIMILAR MATERIAL WITH OPENINGS HAVING A LEAST DIMENSION OF 1/16 INCH (1.6 MM) MINIMUM AND 1/4 INCH (6.4 MM) MAXIMUM.
- ALL FLASHING TO MEET CODES. FOLLOW MANUFACTURER'S DATA SHEET AND SMACNA STANDARDS.
- STRUCTURAL CONNECTORS LISTED ARE FOR EXAMPLE. OTHER PRODUCTS MAY BE SUBSTITUTED FOR ANY CONNECTORS LISTED PROVIDED THEY MEET THE REQUIRED LOAD CAPACITIES. FOLLOW MANUFACTURER'S INSTALLATION DATA. ANY CONNECTORS EXPOSED TO THE WEATHER SHALL BE HOT DIPPED GALVANIZED.
- ANCHOR BOLT MINIMUM EMBEDMENT IS 7" UNLESS OTHERWISE NOTED.
- ELECTRICAL INFORMATION IS DIAGRAMMATIC ONLY.
- ALL FIXTURES AND EQUIPMENT MUST MEET THE OWNER'S APPROVAL PRIOR TO PURCHASE AND INSTALLATION
- ALL WOOD IN CONTACT WITH MASONRY OR CONCRETE SHALL BE PRESSURE TREATED. ALL STRUCTURAL WOOD EXPOSED TO WEATHER SHALL BE PRESSURE TREATED.
- ALL WOOD AND WOOD CONSTRUCTION SHALL COMPLY WITH THE RELEVANT CODES AND SPECIFICATIONS AND THE 'AMERICAN INSTITUTE OF TIMBER CONSTRUCTION' (STANDARD MANUAL)
- APPLICATION OF PAINT OR OTHER COATING SHALL BE IN STRICT ACCORDANCE WITH THE MANUFACTURER'S DIRECTIONS. READY-MIXED PAINT SHALL NOT BE THINNED, EXCEPT AS PERMITTED IN THE APPLICATION INSTRUCTIONS.
- ALL SURFACES TO BE FINISHED SHALL BE CLEAN AND FREE OF FOREIGN MATERIALS, (DIRT, GREASE, ASPHALT, RUST, ETC.)
- APPLICATION SHALL BE IN A WORKMANLIKE MANNER PROVIDING A SMOOTH SURFACE. APPLICATION RATE SHALL BE THAT RECOMMENDED BY THE MANUFACTURER. APPLICATION MAY BE BY BRUSH OR ROLLER, OR MAY BE BY SPRAY IF PAINT IS FORMULATED FOR SAME.
- PROVIDE EXTERIOR AND INTERIOR SURFACE FINISHES AS SCHEDULED, AS APPROPRIATE FOR THEIR LOCATION OR EXPOSURE TO WEATHER, AND AS RECOMMENDED BY THE MANUFACTURER.
- OTHER FINISHES AS PER CONSTRUCTION DOCUMENTS, FINISH SCHEDULE OR OWNER'S SPECIFICATIONS.
- THE DESIGNER SHALL NOT BE RESPONSIBLE FOR AND WILL NOT HAVE CONTROL OR CHARGE OF CONSTRUCTION MEANS, METHODS, TECHNIQUES, SEQUENCES OR PROCEDURES. NOR WILL HE/SHE BE RESPONSIBLE FOR THE SAFETY PRECAUTIONS AND PROGRAMS IN CONNECTION WITH THE WORK, OR THE CONTRACTOR'S FAILURE TO CARRY OUT THE WORK IN ACCORDANCE WITH THE CONTRACT DOCUMENTS. THE DESIGNER SHALL NOT BE RESPONSIBLE FOR OR HAVE CONTROL OR CHARGE OVER THE ACTS OR OMISSIONS OF THE CONTRACTOR, SUB-CONTRACTORS, OR ANY OF THEIR AGENTS OR EMPLOYEES, OR ANY OTHER PERSONS PERFORMING ANY OF THE WORK.

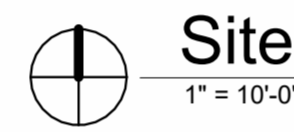

Sketch 1

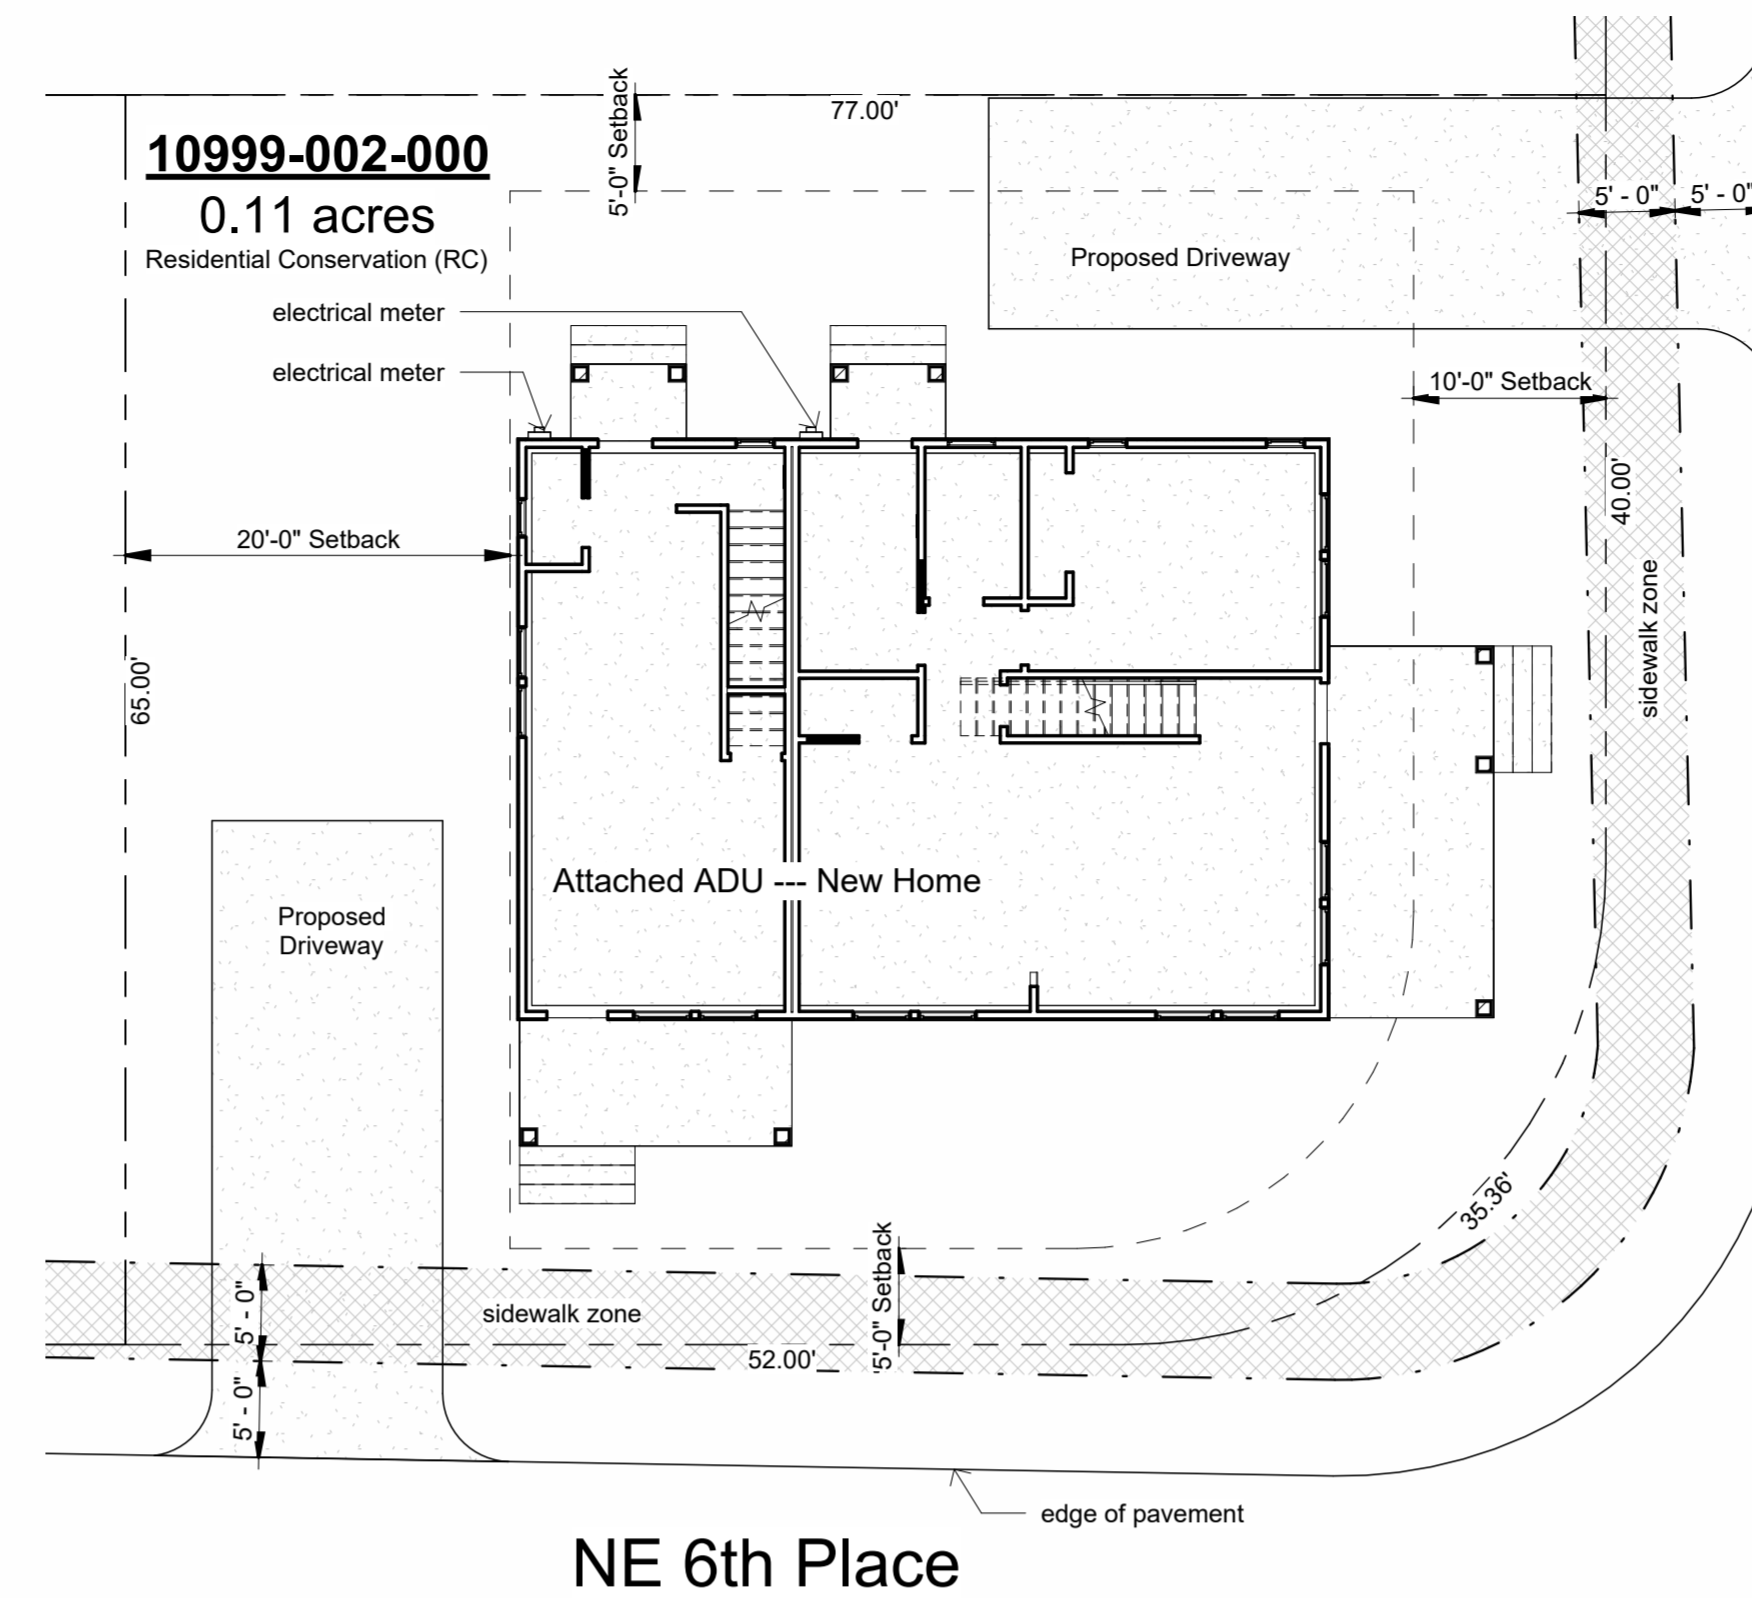

Sketch 2

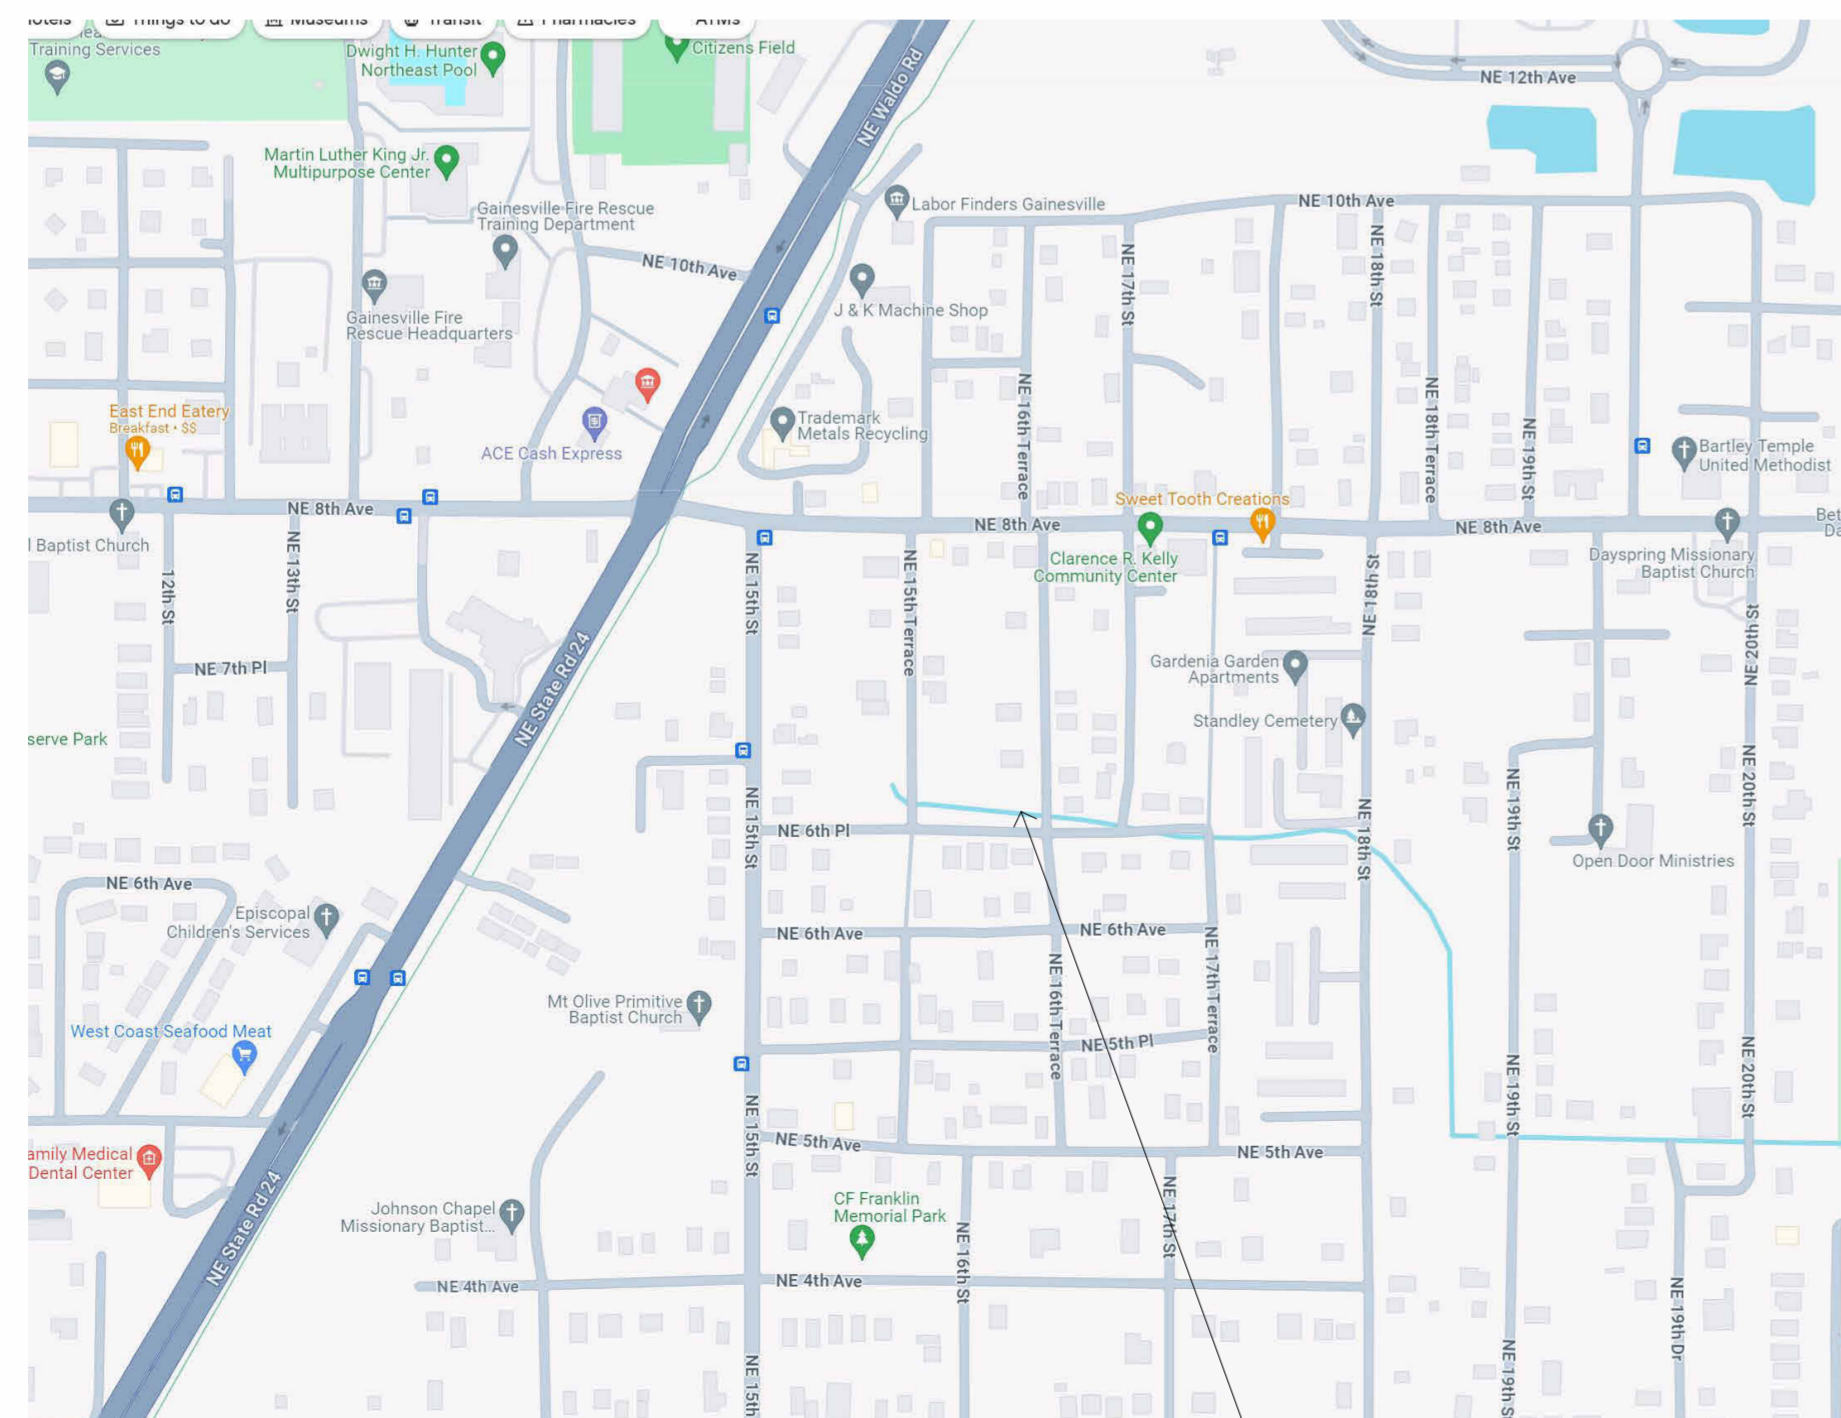

Location Map
12" = 1'-0"

Project Identification
Douglas Residence

Project Location
Unassigned Address 10999-002-000
Gainesville, Florida 32641

Owner
Jonathan Douglas, 832 NW 39th Ave LLC
9200 NW 39th Ave. STE 130-3255
Gainesville, FL 32606

Designer
Bob Harris - dba Bob Harris Design
2351 SW 56th Avenue
Gainesville, Florida 32608

Building Code
All areas of construction shall comply with Florida Building Code 8th Addition 2023


- Project Scope**
- New Home
 - Attached ADU

Sheet List	
Sheet Number	Sheet Name
A0	Cover, Location, Notes
A1	First Floor Plan
A2	Second Floor Plan
A3	Elevations
A4	Electrical Plan

Area Schedule (Gross Building)	
Area	Type

ADU	
850 SF	Conditioned
124 SF	Porches
974 SF	

Home	
1670 SF	Conditioned
191 SF	Porches
1861 SF	
2835 SF	

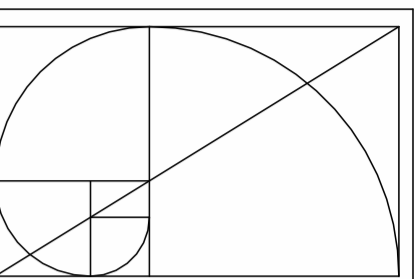

BOB HARRIS DESIGN

bobharrisdesign.com
bh@bobharrisdesign.com
352-317-6644
2351 SW 5th Avenue

CLIENT

Jonathan Douglas, 832 NW 39th Ave LLC

Douglas Residence
Lot 23 East Home
Unassigned Address 10999-002-000
Gainesville, Florida 32641

Revision Date
Number Date

Date:
01/23/2024

Drawn:
Bob Harris

Description:
Cover, Location, Notes


SHEET
A0
OF
5

50%


50%

Window Schedule						
Mark	Width	Height	Description	Comments	Head Height	Count
A	3'-0"	5'-0"	Single Hung		6'-8"	20
B	2'-0"	5'-0"	Single Hung		6'-8"	6
C	3'-0"	3'-0"	Single Hung		6'-8"	2
D	4'-0"	1'-8"	Awning		6'-8"	3
E	3'-0"	1'-8"	Casement Left		6'-8"	2
F	3'-0"	1'-8"	Casement Right		6'-8"	2
G	2'-6"	1'-8"	Awning		6'-8"	1
H	2'-8"	3'-0"	Single Hung		6'-8"	2

Door Schedule						
Mark	Width	Height	Function	Location	Description	Comments
First Floor						
01	3'-0"	6'-8"	Exterior	Entry Porch 1	3/4 Lite Patterned Glass	
02	3'-0"	6'-8"	Exterior	Entry Porch 2	3/4 Lite Patterned Glass	
03	2'-8"	6'-8"	Exterior	Kitchen 2	Half Lite	
04	2'-8"	6'-8"	Exterior	Utility	Half Lite	
05	2'-8"	6'-8"	Interior	Bath 1		
06	2'-8"	6'-8"	Interior	Bedroom 1		
07	2'-0"	6'-0"	Interior	Closet	Custom Cut	
08	5'-0"	6'-8"	Interior	Closet 1	Pair Sliding Doors	
09	2'-6"	6'-8"	Interior	Laundry		
10	2'-8"	6'-8"	Interior	Pantry	Pocket Door Full Lite Frosted Glass	
11	2'-6"	6'-8"	Interior	Pdr.	Pocket Door	
12	2'-8"	6'-8"	Interior	Utility	Pocket Door Full Lite Frosted Glass	
Second Floor						
13	1'-8"	6'-8"	Interior			
14	2'-6"	6'-8"	Interior	Bath 1a		
15	2'-6"	6'-8"	Interior	Bath 2		
16	2'-6"	6'-8"	Interior	Bedroom 1a		
17	2'-8"	6'-8"	Interior	Bedroom 2		
18	2'-6"	6'-8"	Interior	Bedroom 2a		
19	2'-6"	6'-8"	Interior	Bedroom 2a	Pocket Door	
20	2'-8"	6'-8"	Interior	Bedroom 3		
21	5'-0"	6'-8"	Interior	Closet 1	Pair Sliding Doors	
22	5'-0"	6'-8"	Interior	Closet 2	Pair Sliding Doors	
23	2'-0"	6'-8"	Interior	Closet 3		
24	2'-6"	6'-8"	Interior	M. Bath	Pocket Door	
25	2'-8"	6'-8"	Interior	Master Bedroom		
26	2'-8"	6'-8"	Interior	Mech		
27	3'-0"	6'-8"	Interior	Mech 1		
28	2'-4"	6'-8"	Interior	W.I.C.		

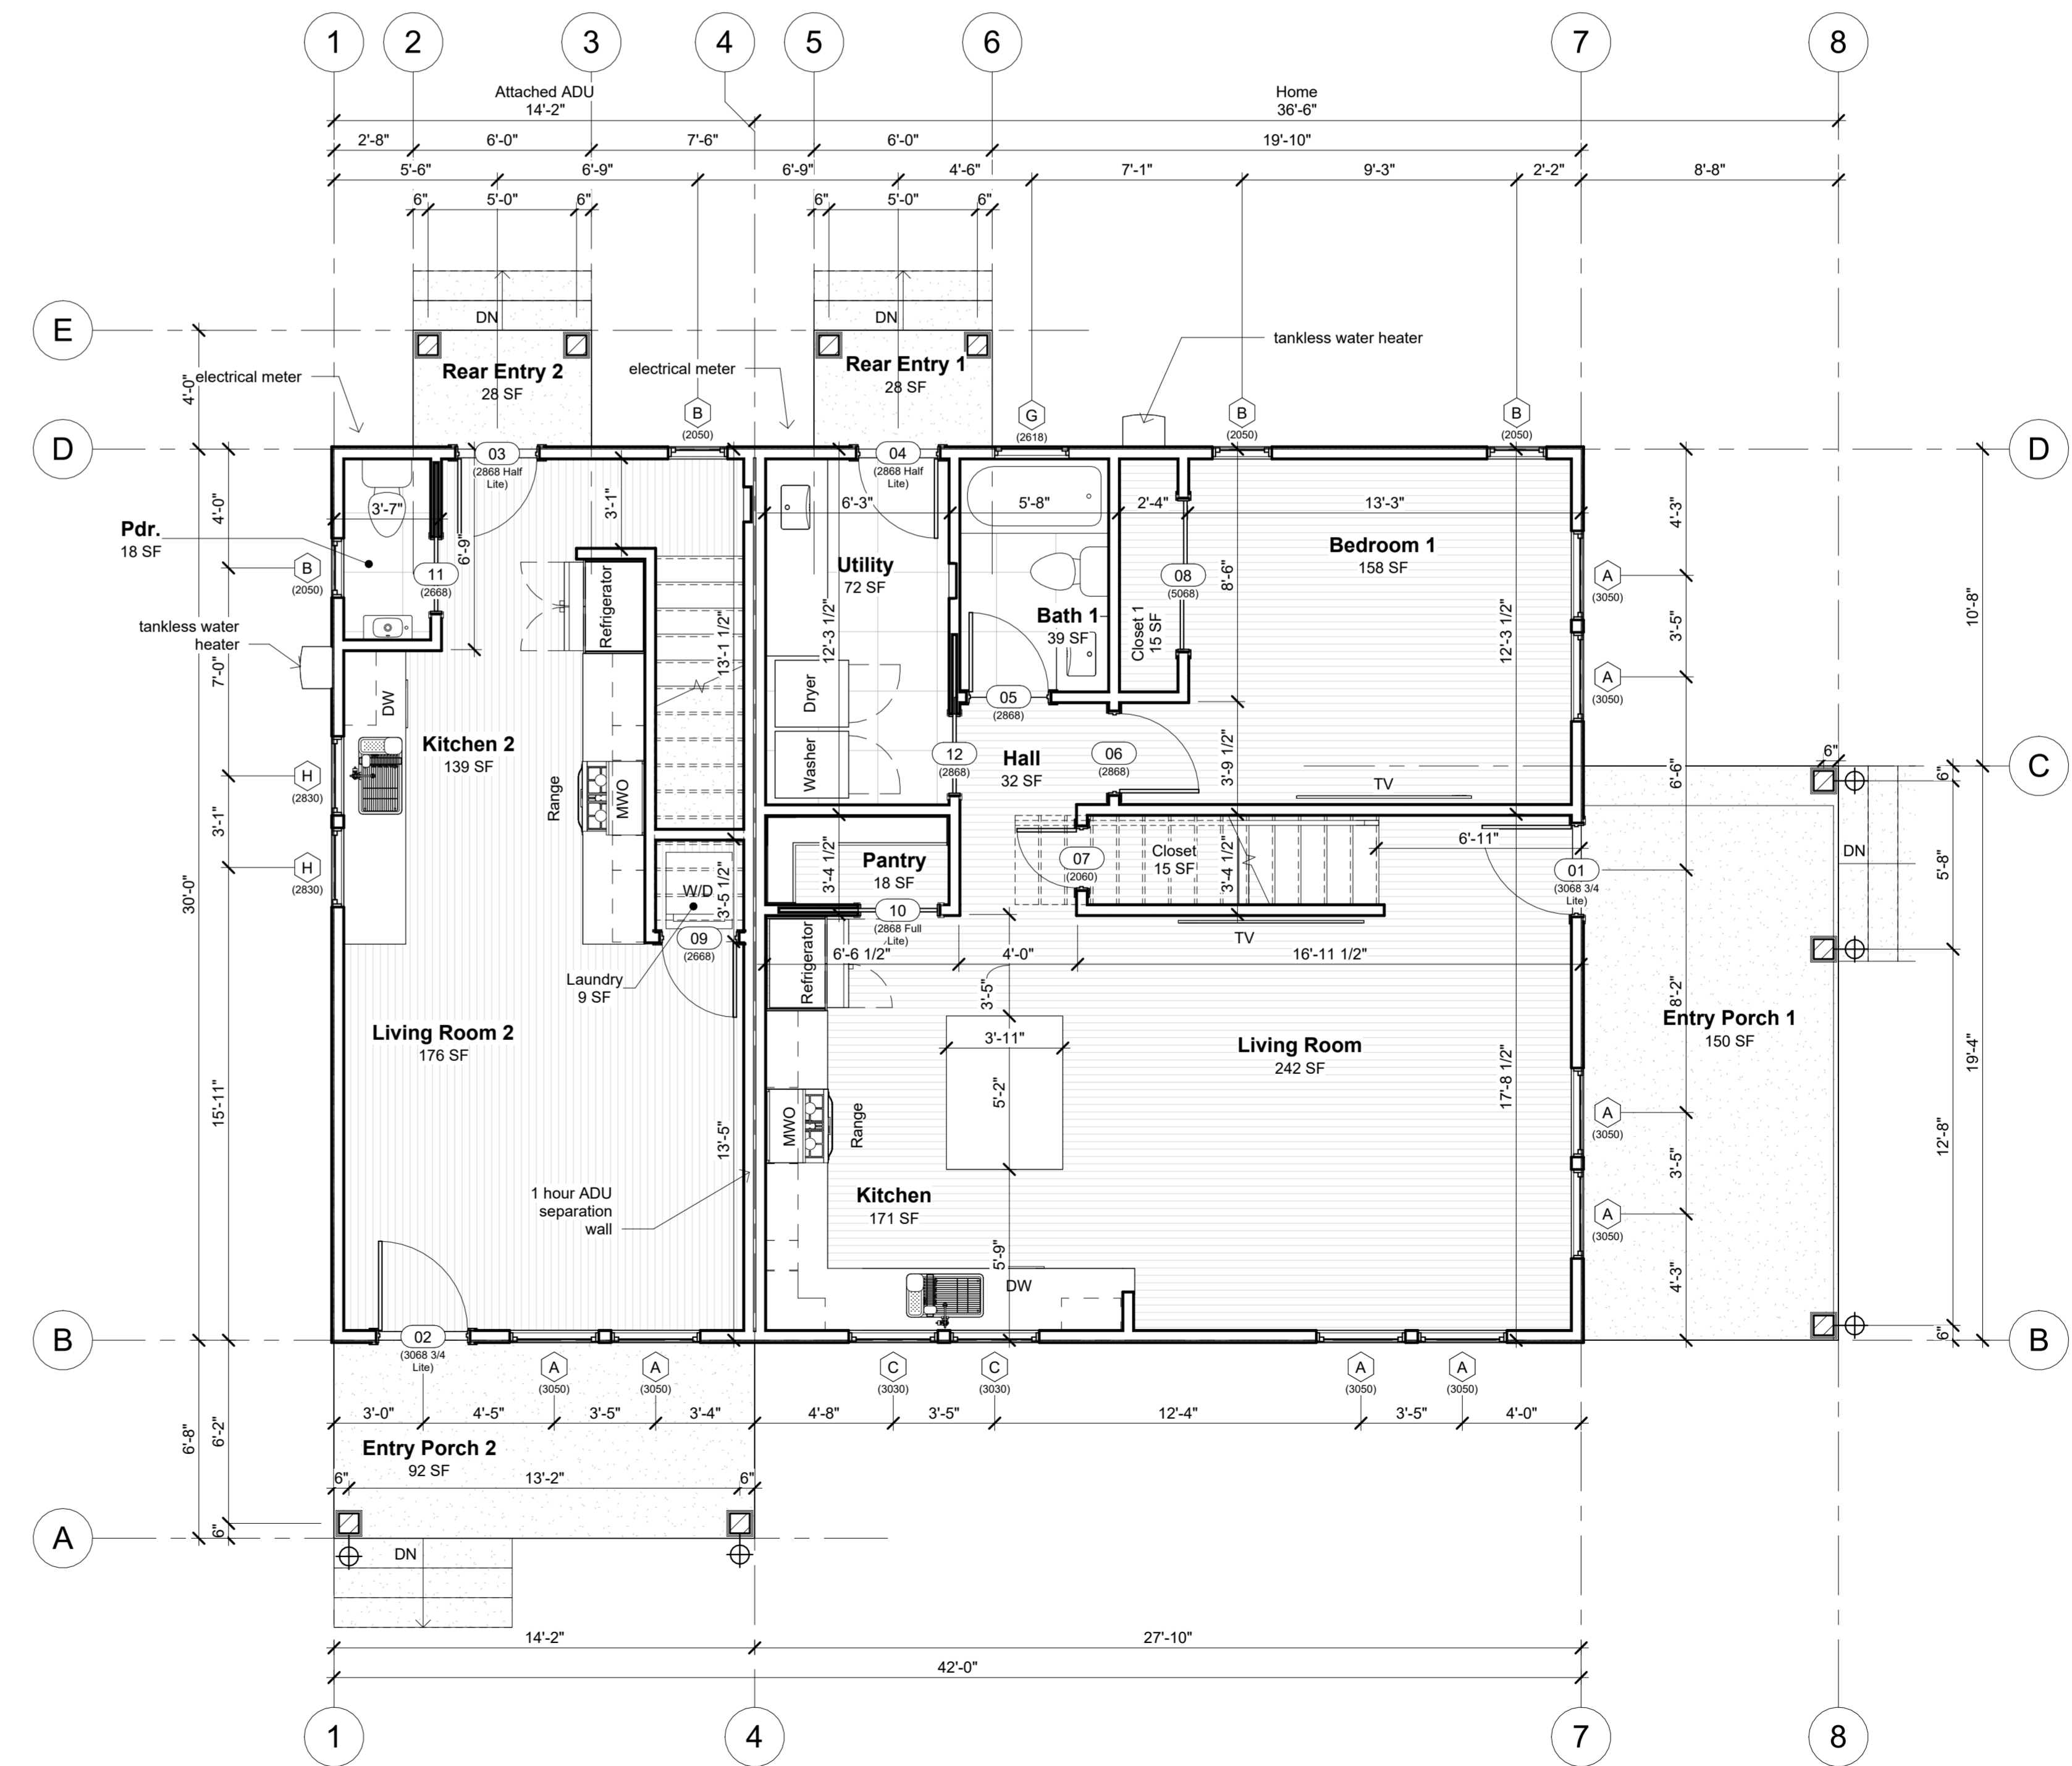

First Floor Plan
1/4" = 1'-0"

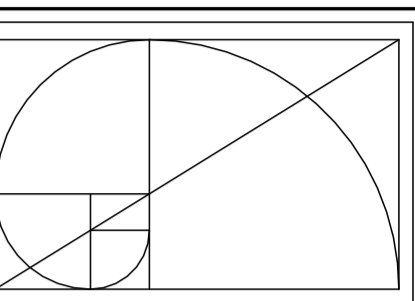

BOB HARRIS DESIGN
bobharrisdesign.com
bh@bobharrisdesign.com
352-317-6644
2351 SW 5th Avenue

CLIENT
Jonathan Douglas, 832
NW 39th Ave LLC

Douglas Residence
Lot 23 East Home
Unassigned Address 10999-002-000
Gainesville, Florida 32641

Revision Date
Number Date

Date: 01/23/2024
Drawn: Bob Harris
Description: First Floor Plan


SHEET
A1
OF
5

50%

50%

Window Schedule						
Mark	Width	Height	Description	Comments	Head Height	Count
A	3'-0"	5'-0"	Single Hung		6'-8"	20
B	2'-0"	5'-0"	Single Hung		6'-8"	6
C	3'-0"	3'-0"	Single Hung		6'-8"	2
D	4'-0"	1'-8"	Awning		6'-8"	3
E	3'-0"	1'-8"	Casement Left		6'-8"	2
F	3'-0"	1'-8"	Casement Right		6'-8"	2
G	2'-6"	1'-8"	Awning		6'-8"	1
H	2'-8"	3'-0"	Single Hung		6'-8"	2

Door Schedule						
Mark	Width	Height	Function	Location	Description	Comments
First Floor						
01	3'-0"	6'-8"	Exterior	Entry Porch 1	3/4 Lite Patterned Glass	
02	3'-0"	6'-8"	Exterior	Entry Porch 2	3/4 Lite Patterned Glass	
03	2'-8"	6'-8"	Exterior	Kitchen 2	Half Lite	
04	2'-8"	6'-8"	Exterior	Utility	Half Lite	
05	2'-8"	6'-8"	Interior	Bath 1		
06	2'-8"	6'-8"	Interior	Bedroom 1		
07	2'-0"	6'-0"	Interior	Closet 1	Custom Cut	
08	5'-0"	6'-8"	Interior	Closet 1	Pair Sliding Doors	
09	2'-6"	6'-8"	Interior	Laundry		
10	2'-8"	6'-8"	Interior	Pantry	Pocket Door Full Lite Frosted Glass	
11	2'-6"	6'-8"	Interior	Pdr.	Pocket Door	
12	2'-8"	6'-8"	Interior	Utility	Pocket Door Full Lite Frosted Glass	
Second Floor						
13	1'-8"	6'-8"	Interior			
14	2'-6"	6'-8"	Interior	Bath 1a		
15	2'-6"	6'-8"	Interior	Bath 2		
16	2'-6"	6'-8"	Interior	Bedroom 1a		
17	2'-8"	6'-8"	Interior	Bedroom 2		
18	2'-6"	6'-8"	Interior	Bedroom 2a		
19	2'-6"	6'-8"	Interior	Bedroom 2a	Pocket Door	
20	2'-8"	6'-8"	Interior	Bedroom 3		
21	5'-0"	6'-8"	Interior	Closet 1	Pair Sliding Doors	
22	5'-0"	6'-8"	Interior	Closet 2	Pair Sliding Doors	
23	2'-0"	6'-8"	Interior	Closet 3		
24	2'-6"	6'-8"	Interior	M. Bath	Pocket Door	
25	2'-8"	6'-8"	Interior	Master Bedroom		
26	2'-8"	6'-8"	Interior	Mech		
27	3'-0"	6'-8"	Interior	Mech 1		
28	2'-4"	6'-8"	Interior	W.I.C.		

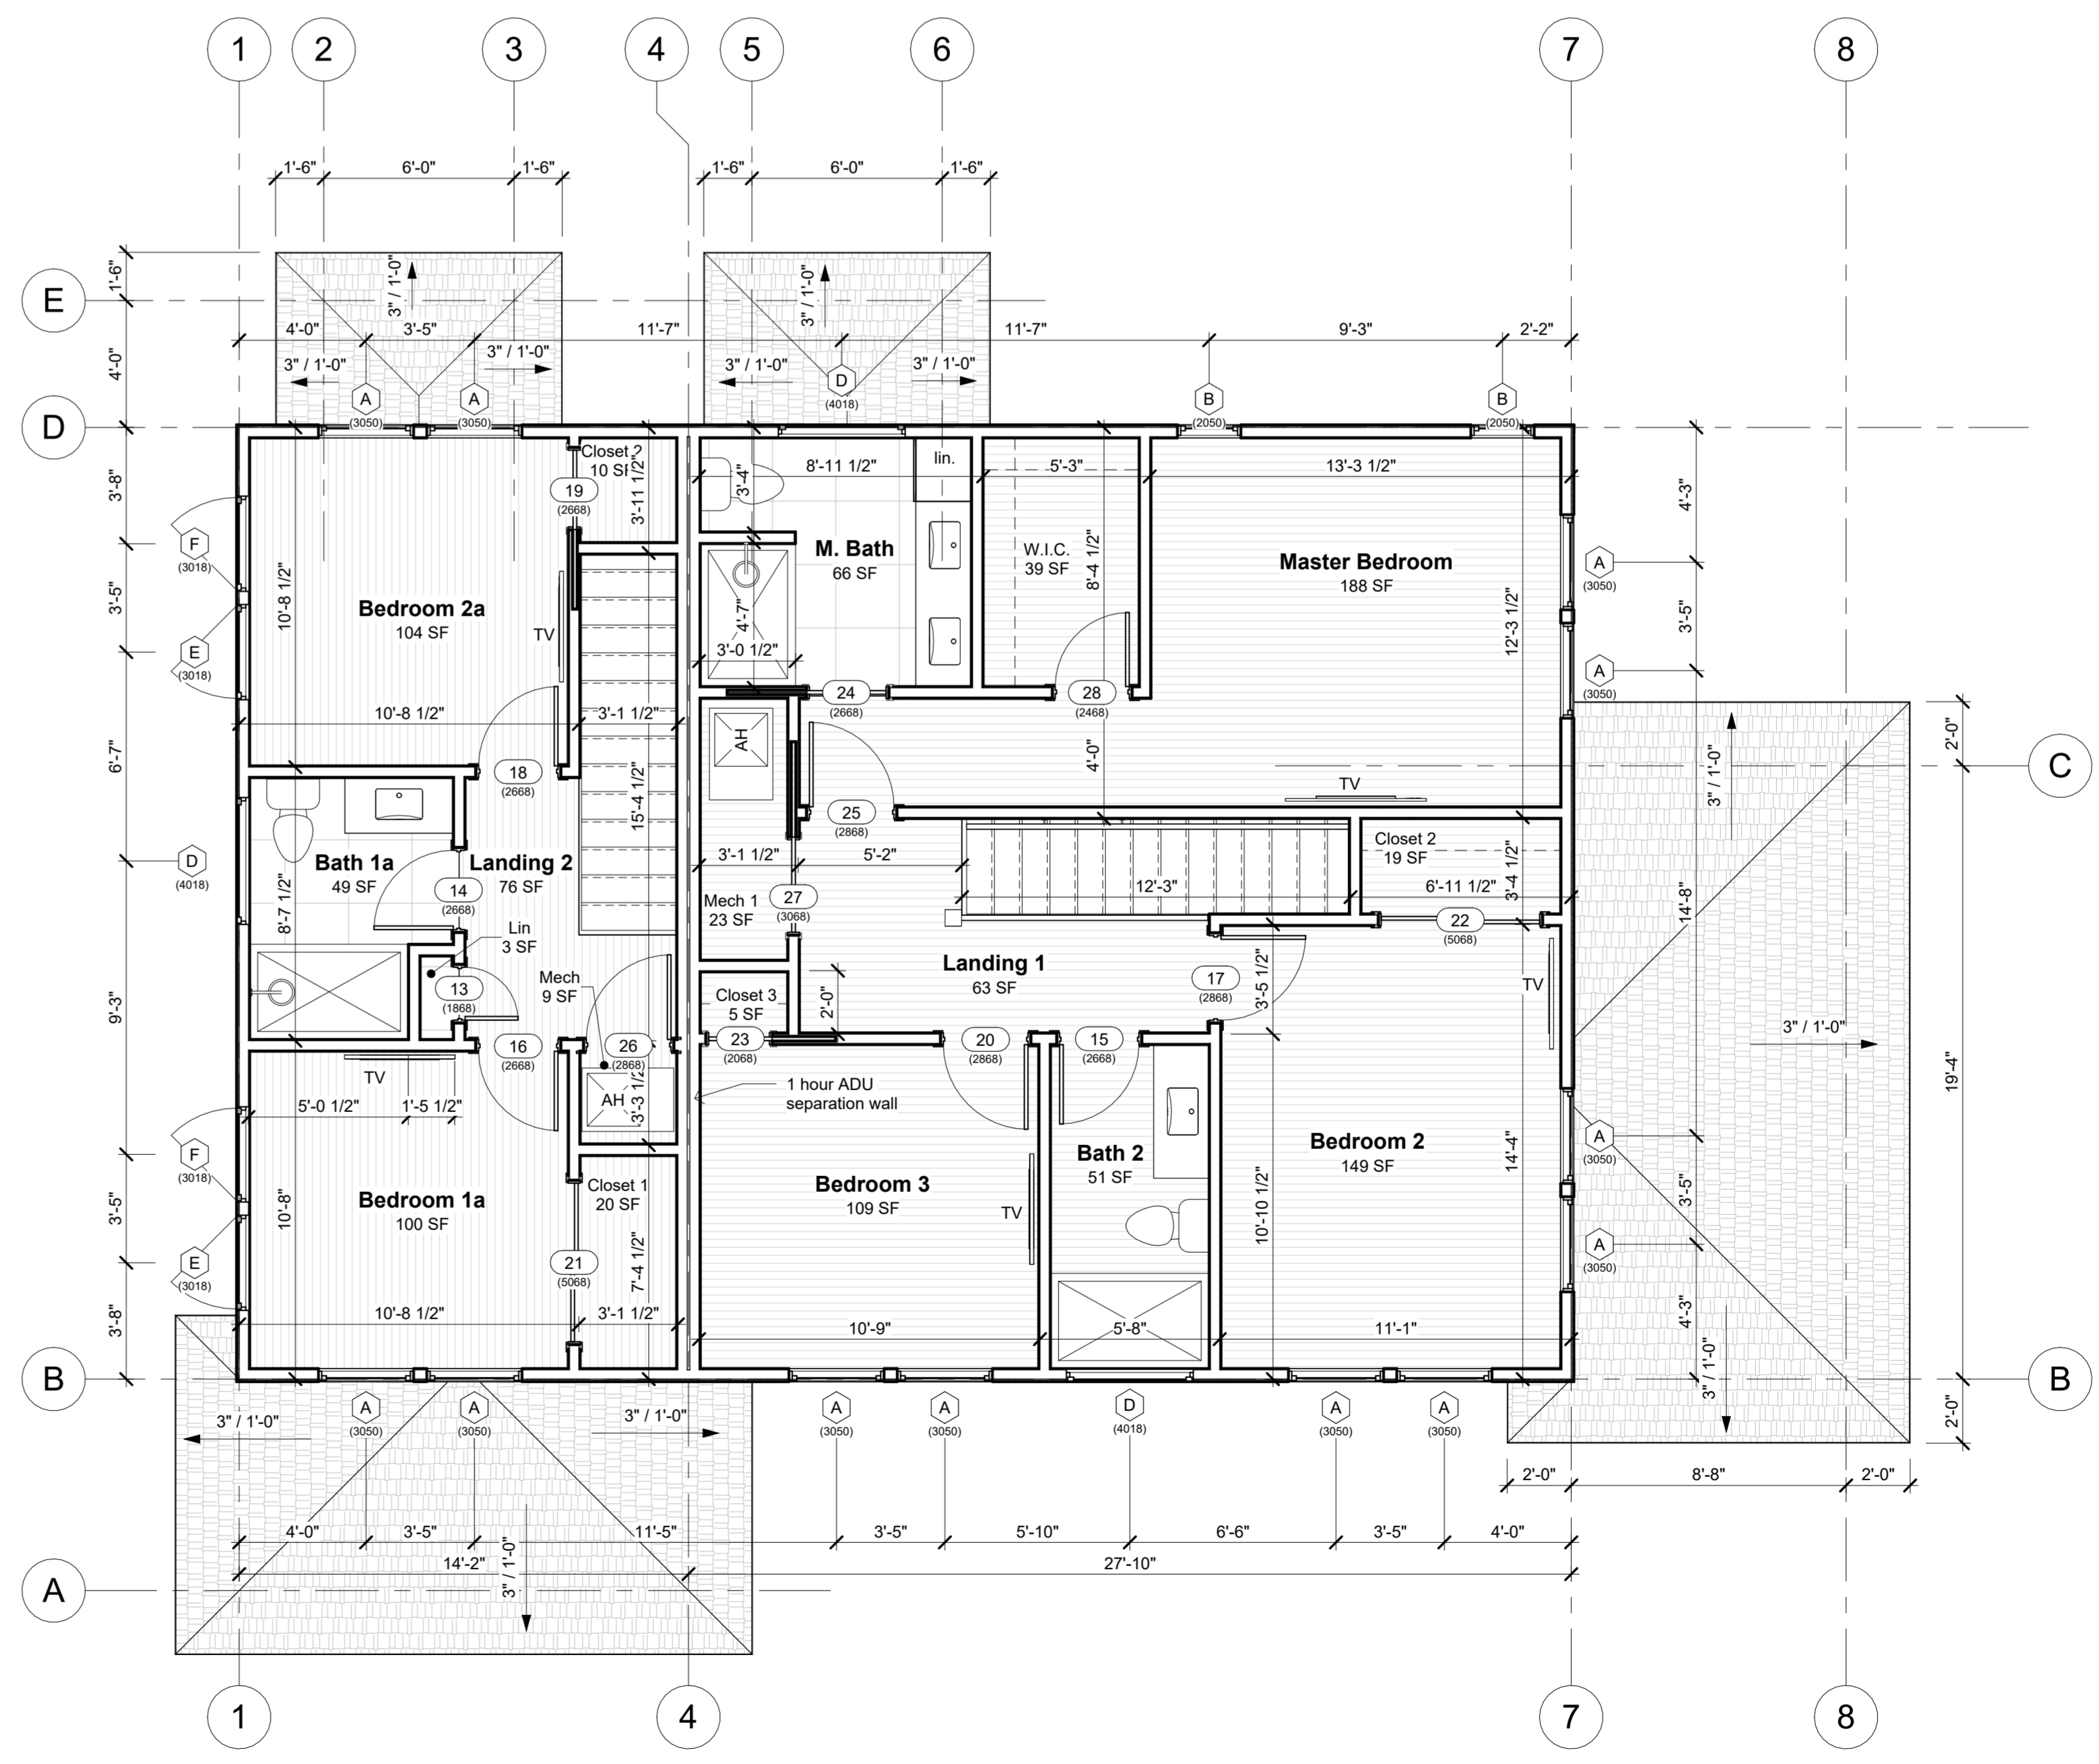

Second Floor Plan
1/4" = 1'-0"

BOB HARRIS DESIGN
bobharrisdesign.com
bh@bobharrisdesign.com
352-317-6644
2351 SW 5th Avenue

CLIENT
Jonathan Douglas, 832
NW 39th Ave LLC

Douglas Residence
Lot 23 East Home
Unassigned Address 10999-002-000
Gainesville, Florida 32641


Revision Date
Number Date

Date: 01/23/2024
Drawn: Bob Harris
Description: Second Floor Plan


SHEET
A2
OF
5

50%


50%

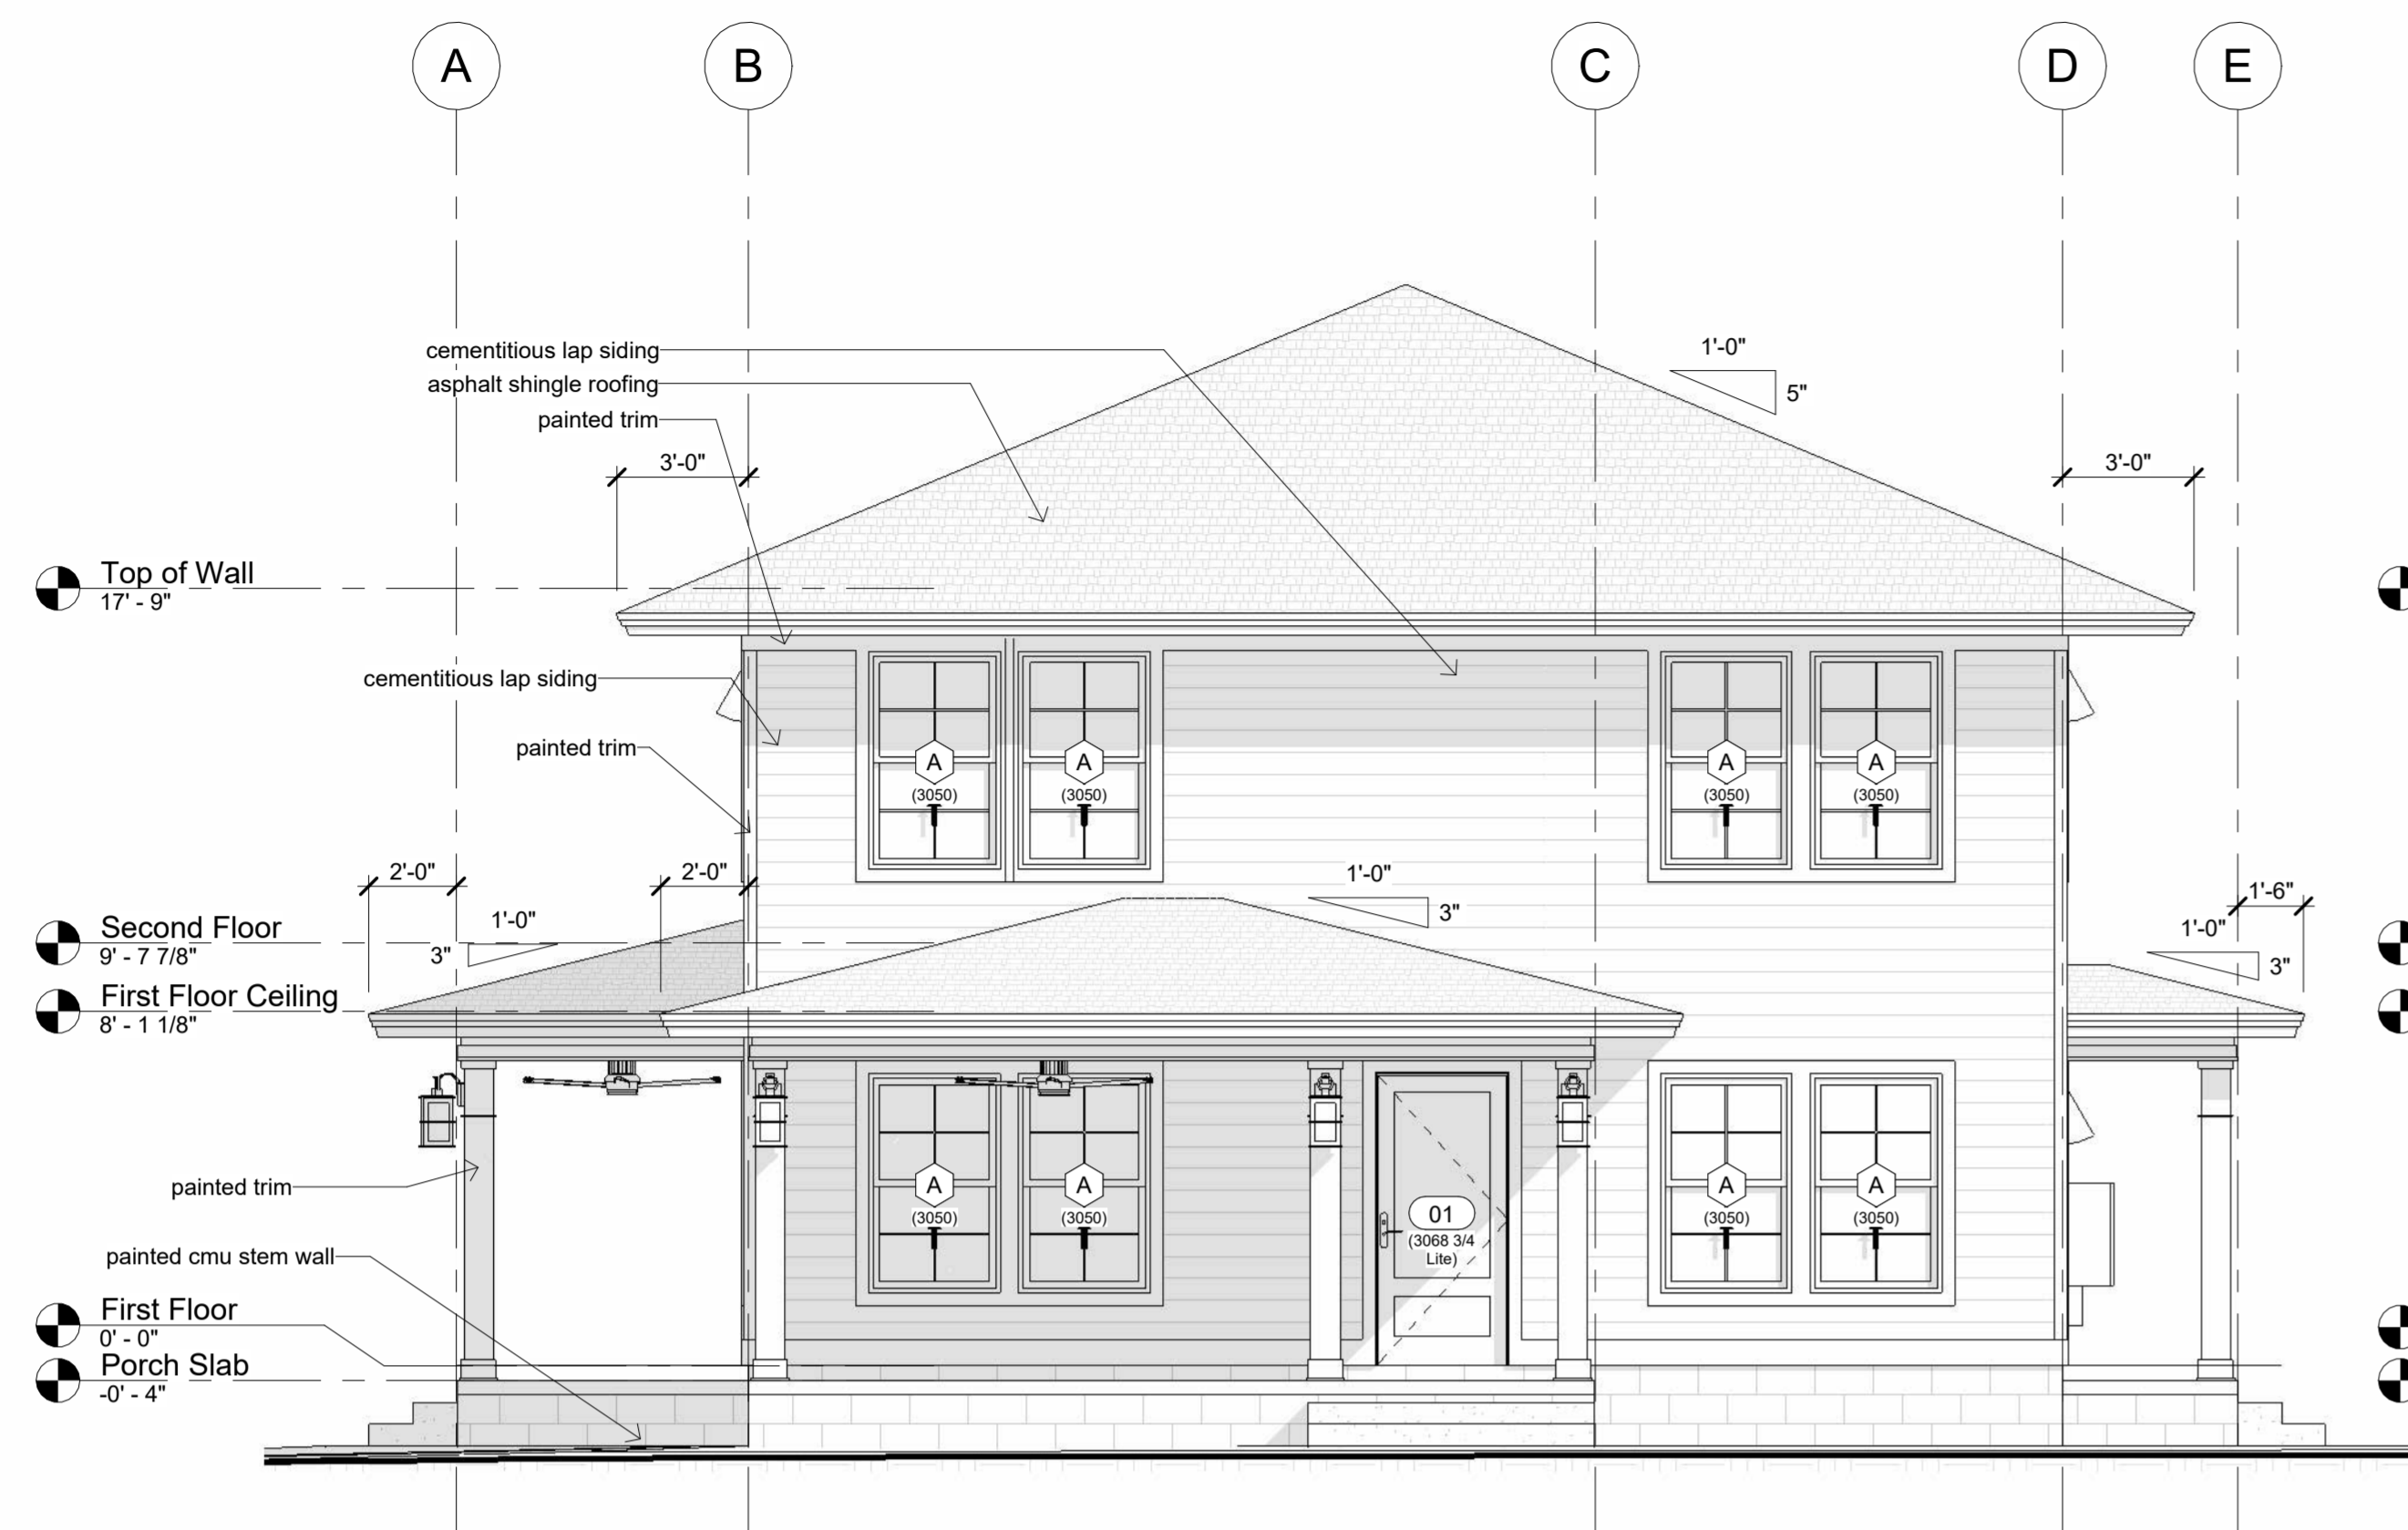


East Elevation
1/4" = 1'-0"

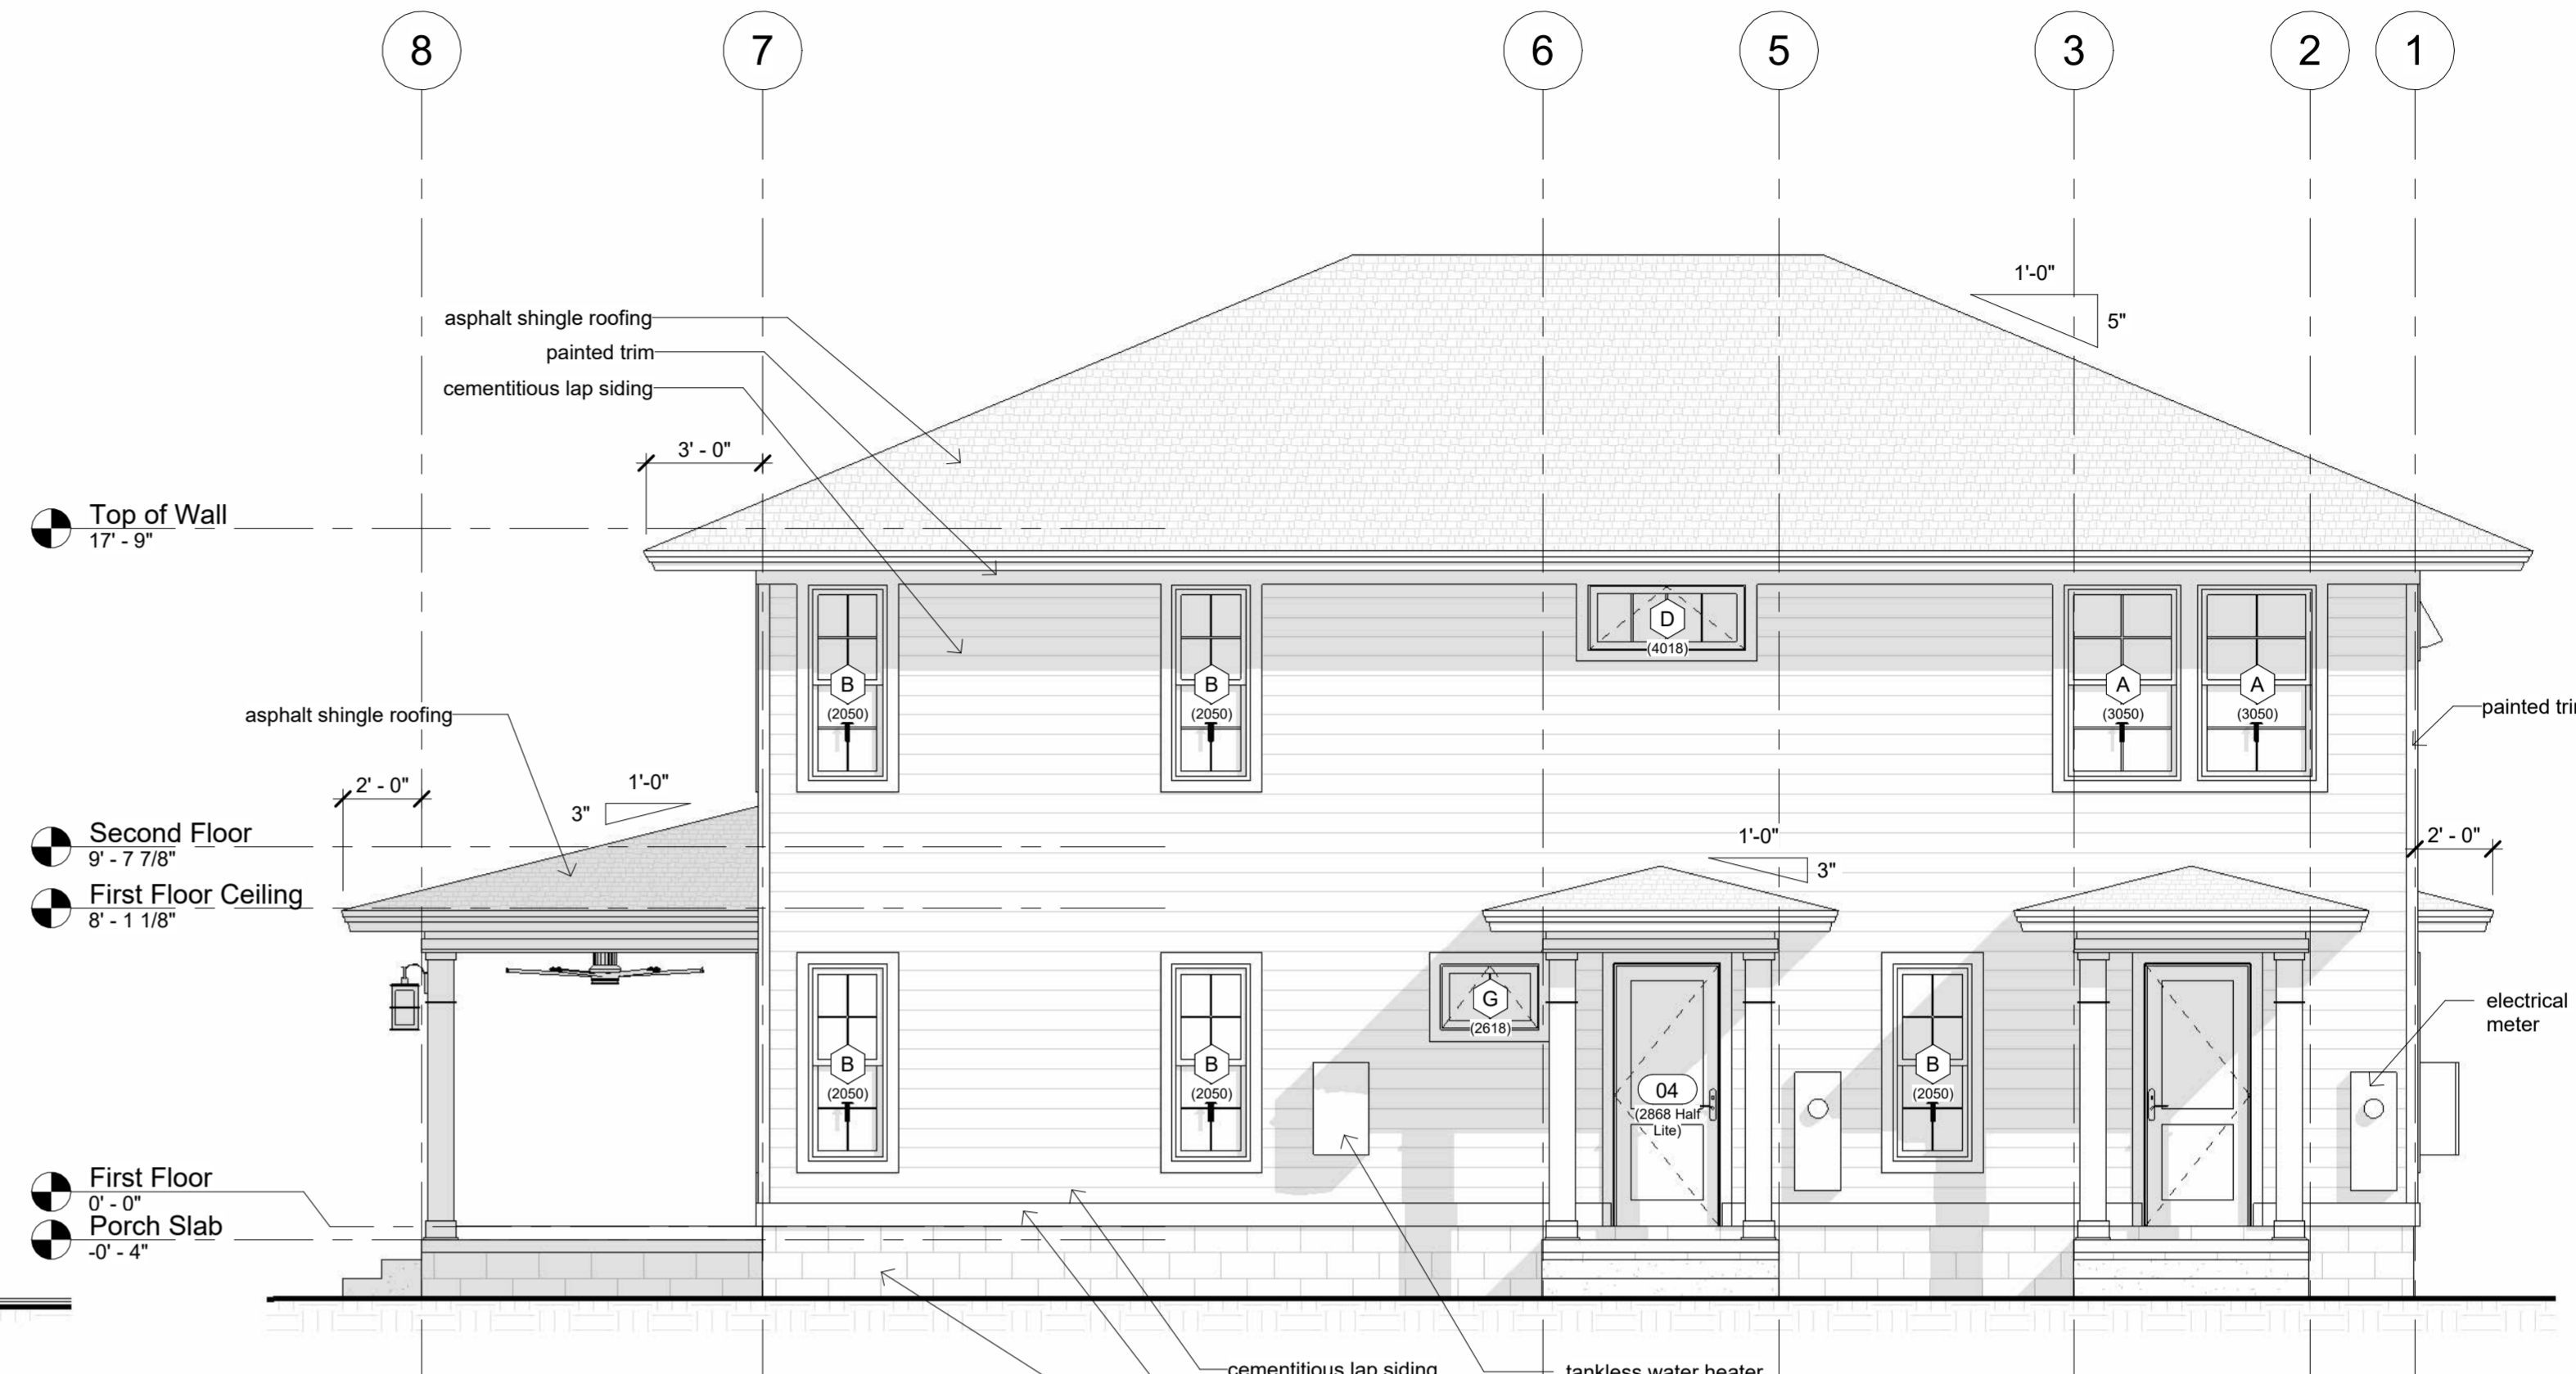


North Elevation
1/4" = 1'-0"

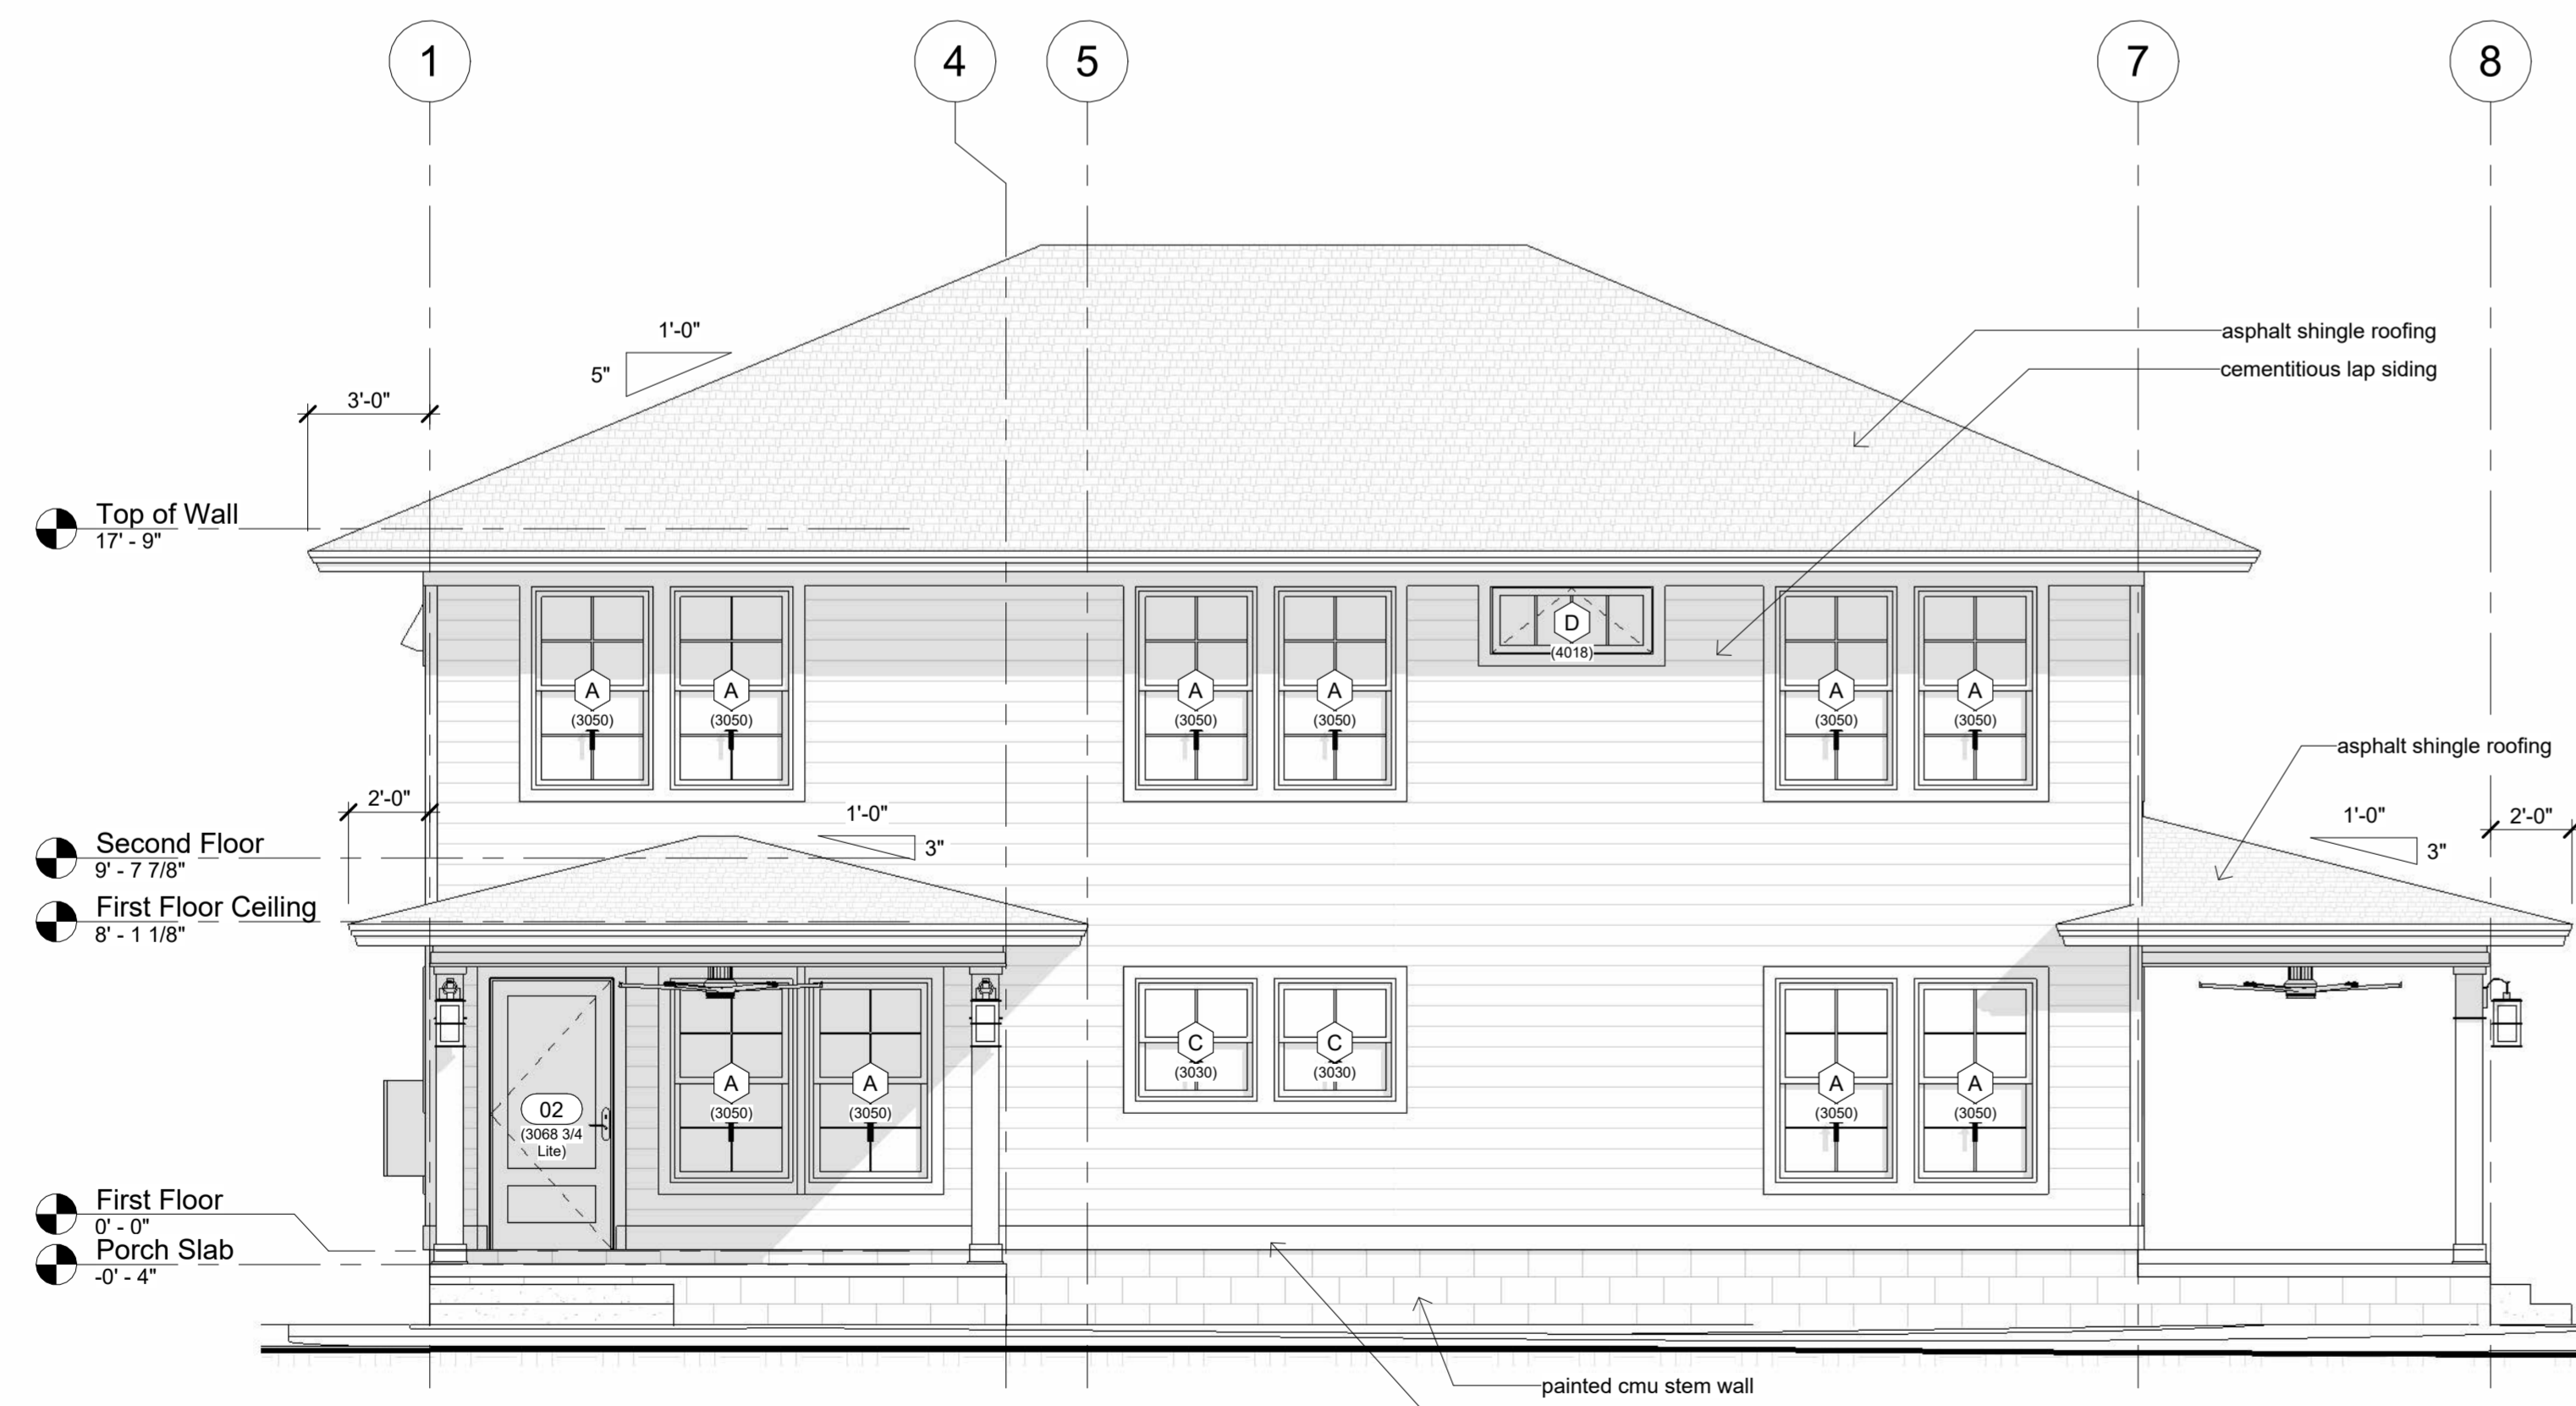

South Elevation
1/4" = 1'-0"

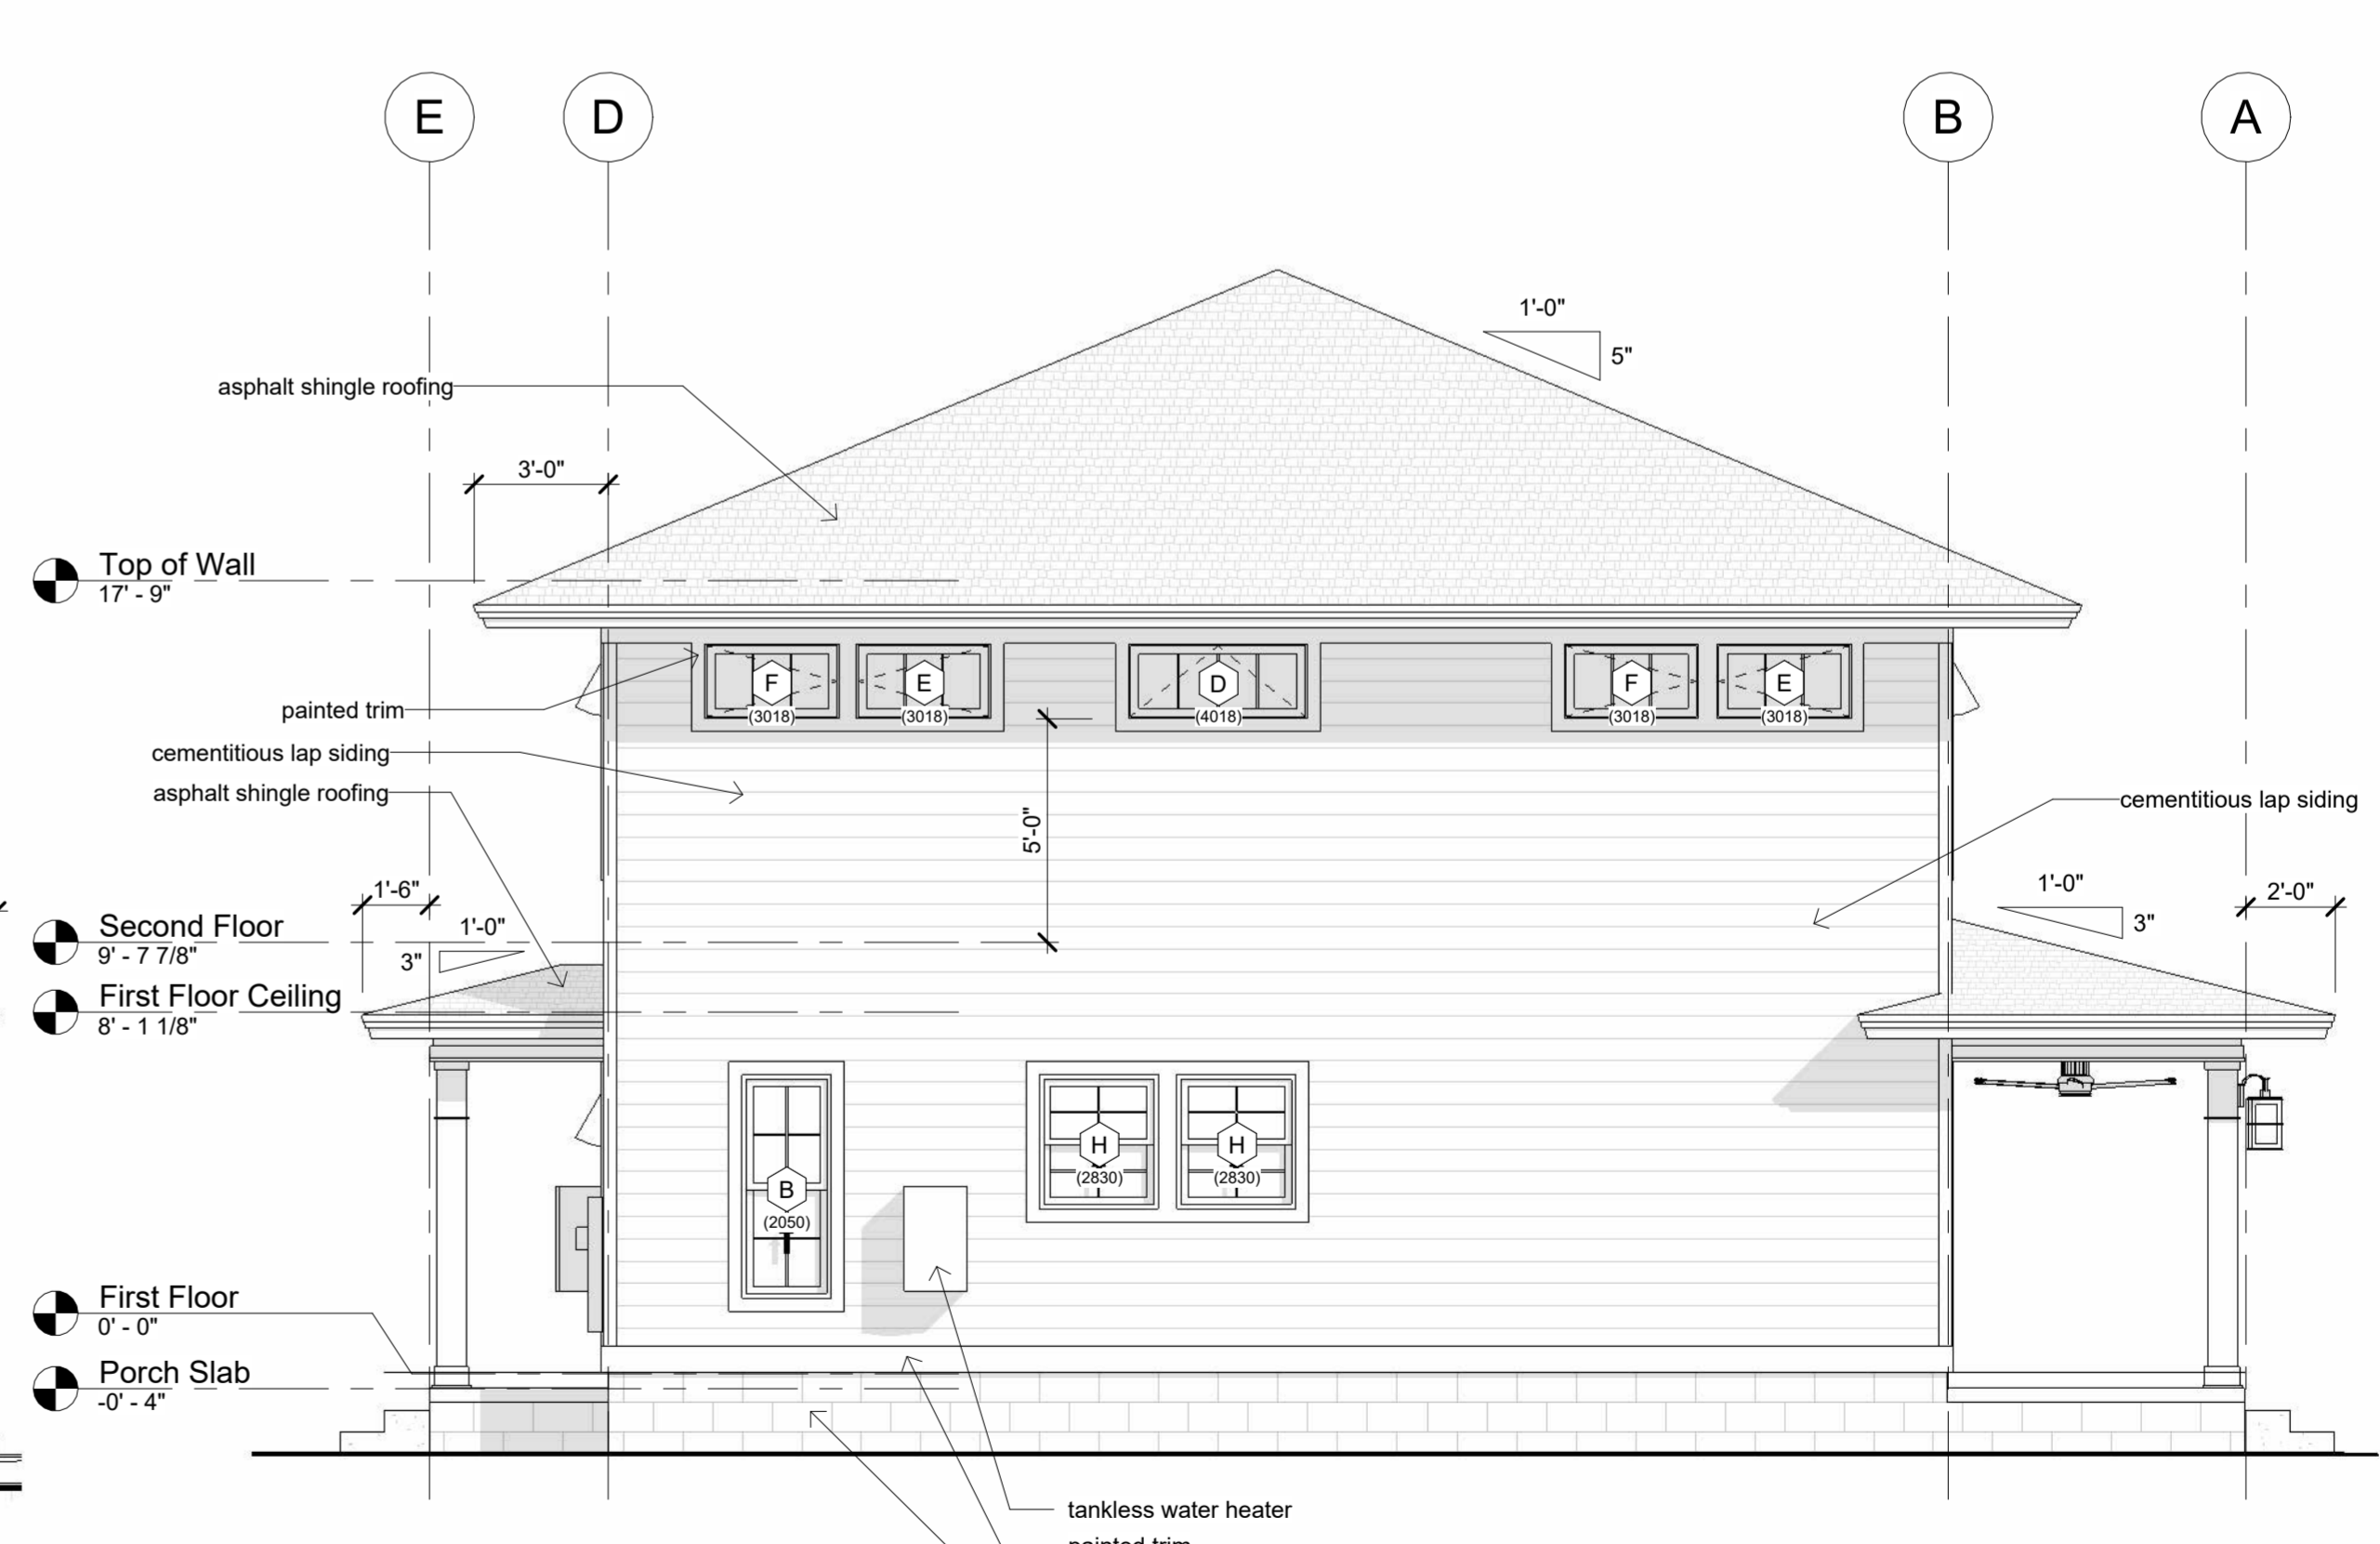

West Elevation
1/4" = 1'-0"

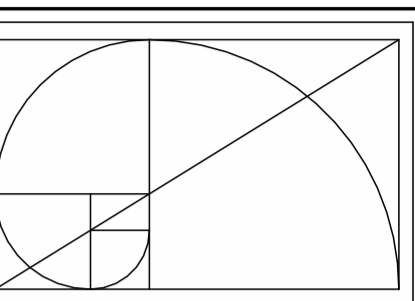

BOB HARRIS DESIGN

bobharrisdesign.com
bh@bobharrisdesign.com
352-317-6644
2351 SW 5th Avenue

CLIENT
Jonathan Douglas, 832
NW 39th Ave LLC

Douglas Residence
Lot 23 East Home
Unassigned Address 10999-002-000
Gainesville, Florida 32641

Revision Date
Number Date

Date: 01/23/2024

Drawn: Bob Harris


Description:

Elevations


SHEET
A3
OF
5

50%

50%

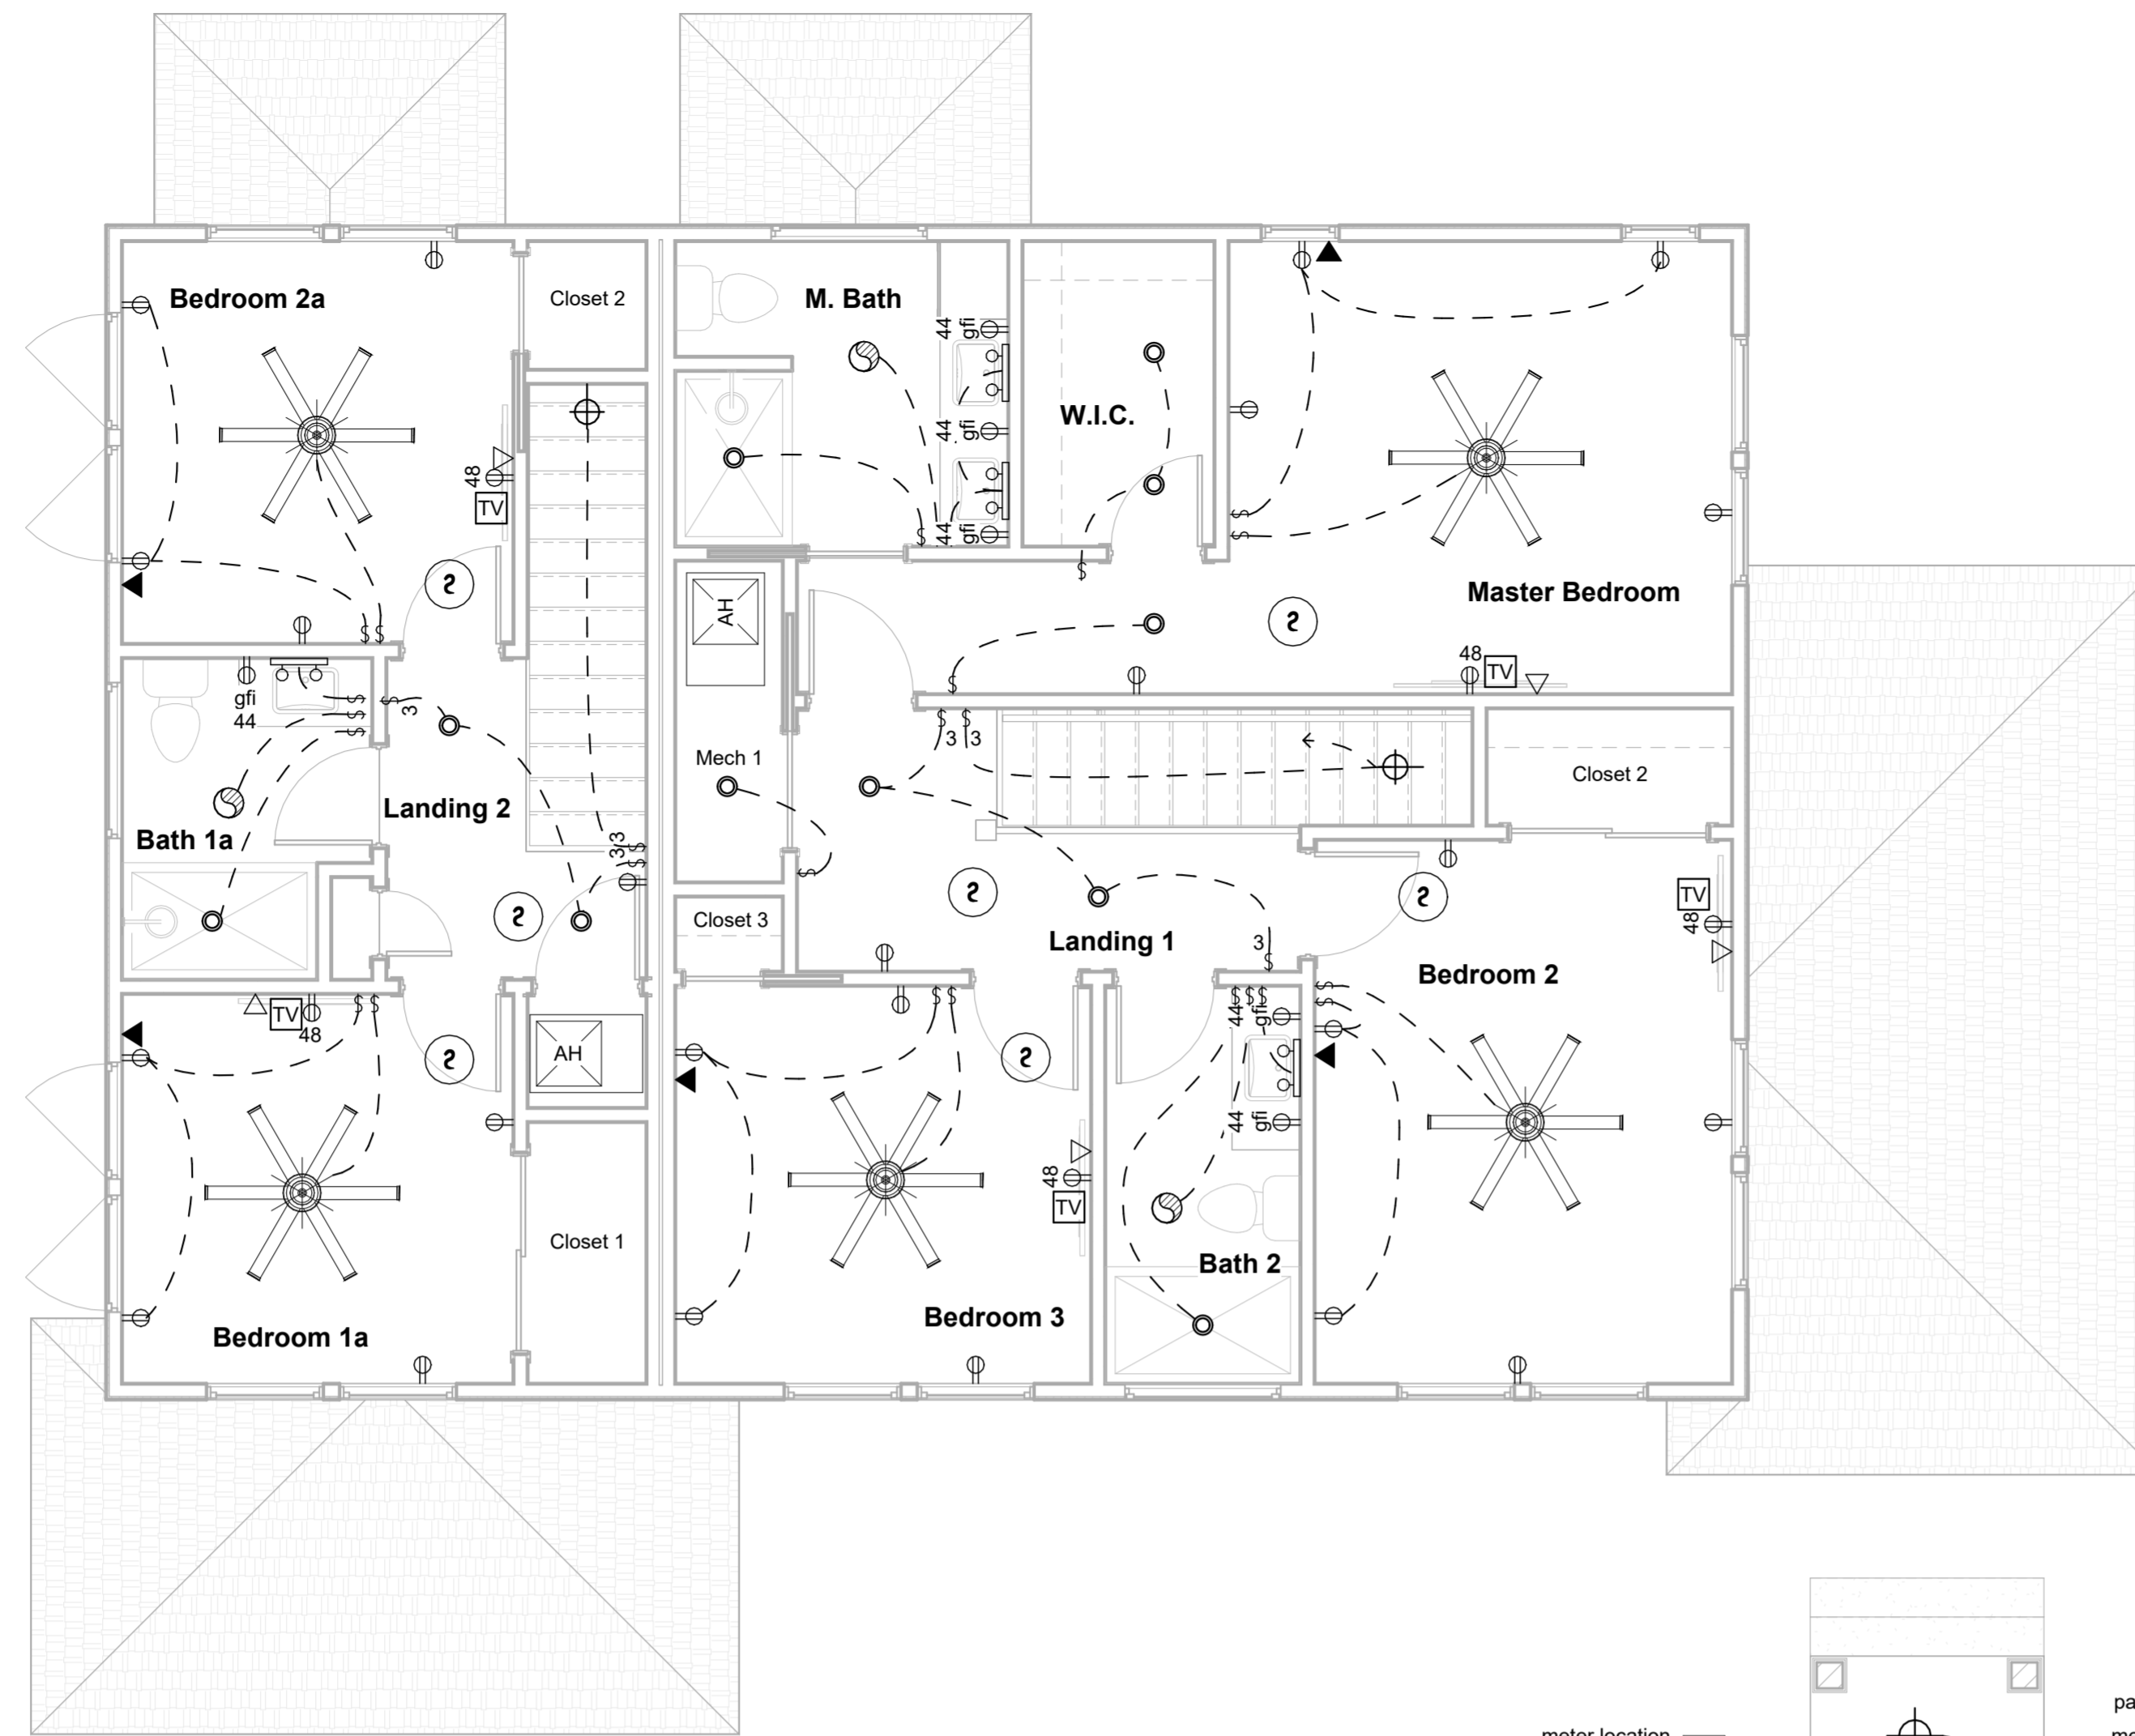

Electrical Plan Second Floor
1/4" = 1'-0"

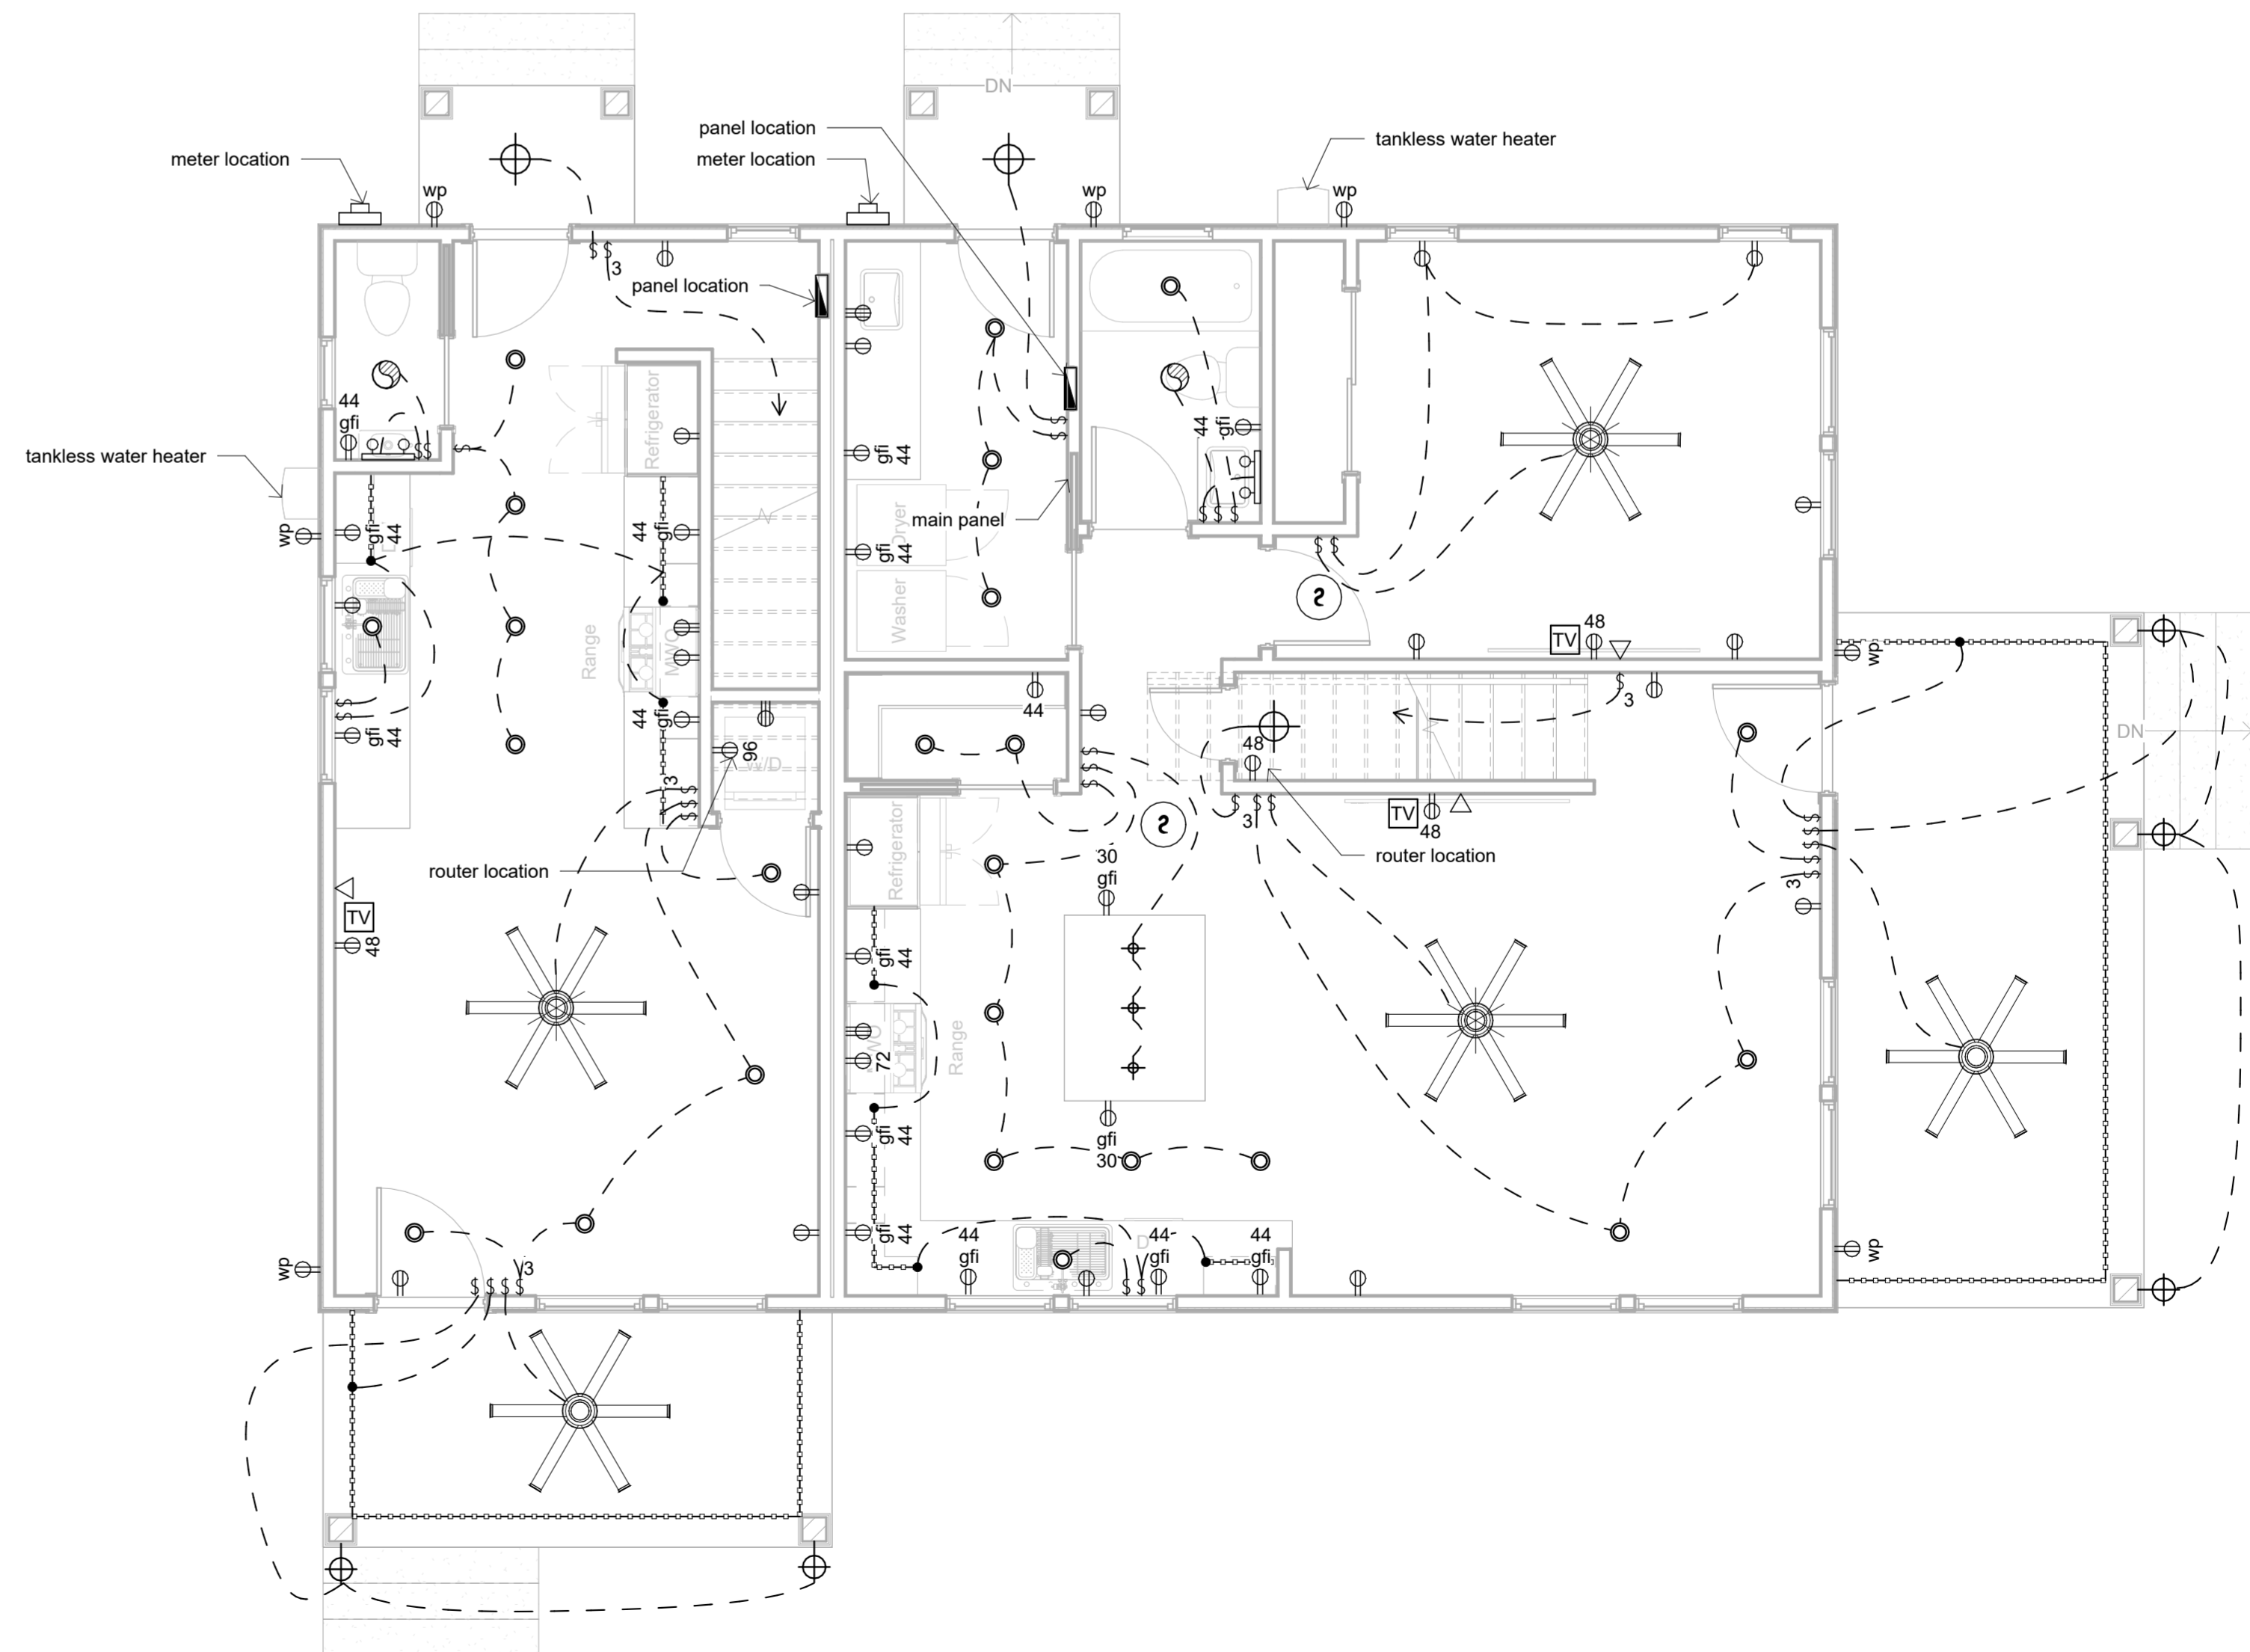


Electrical Plan First Floor
1/4" = 1'-0"

Electrical Legend

	Ceiling Fan
	Ceiling Fan with Light Kit
	Recessed Can Light
	Wall Mounted Light
	Ceiling Mounted Light
	Bathroom Vanity Light
	LED Strip Light - Provide all LED with Dimmable Drivers
	Light Switch
	3 Way Light Switch
	120V Duplex - Number indicates height above floor
	120V Duplex - Ground Fault Interrupted
	120V Duplex - Ground Fault Interrupted In Water Resistant Enclosure
	CAT6 Data Connection
	Telephone Connection
	RJ6 Television Connection
	Exhaust Fan
	Smoke Detector

Electrical General Notes:

- All receptacle outlets not indicated as gfi (ground fault interrupted) shall be afci (arc fault circuit interrupted)
- All receptacle outlets indicated as WP are Ground Fault Interrupted Verify w/ Owner light fixtures to receive dimmers
- Home run all CAT6 data connections to router location. Provide data connection to outside for Cable, Satellite and DSL Internet.
-

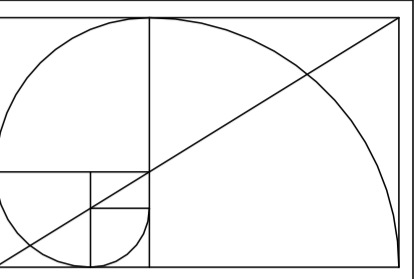

BOB HARRIS DESIGN

bobharrisdesign.com
bh@bobharrisdesign.com
352-317-6644
2351 SW 5th Avenue

CLIENT

Jonathan Douglas, 832 NW 39th Ave LLC

Douglas Residence
Lot 23 East Home
Unassigned Address 10999-002-000
Gainesville, Florida 32641

Revision Date
Number Date

Date: 01/23/2024

Drawn: Bob Harris

Description: Electrical Plan

SHEET

A4

OF 5

50%

50%