

General Notes:

- ALL WORK SHALL CONFORM TO THE LATEST FLORIDA BUILDING CODE, THE NFPA LIFE SAFETY CODE, AND ALL OTHER APPLICABLE CODES AND ORDINANCES. OBTAIN ALL REQUIRED PERMITS FOR THE PROPER LEGAL EXECUTION OF THE WORK DESCRIBED IN THESE DRAWINGS AND SPECIFICATIONS.
- 2. PROVIDE A CONTINUOUS LOAD PATH FROM TRUSSES OR RAFTERS TO FOUNDATION FOR ALL NEW CONSTRUCTION. IF ANY DISCREPANCIES, CALL DESIGNER FOR CLARIFICATION BEFORE PROCEEDING.
- THE CONTRACTOR SHALL VERIFY ALL EXISTING CONDITIONS PRIOR TO STARTING ANY WORK. HE/SHE SHALL NOTIFY THE DESIGNER OF ANY DISCREPANCIES BETWEEN THE CONTRACT DOCUMENTS AND ACTUAL SITE CONDITIONS FOUND DURING OR PRIOR TO DEMOLITION.
- 4. FOUNDATION DESIGN IS BASED ON 2000 PSF STABLE SOIL CONDITIONS.
- PROVIDE TESTING ON SOIL COMPACTION PRIOR TO LAYING STEEL OR POURING CONCRETE. COMPACTION SHOULD ACHIEVE 95% MODIFIED PROCTOR DENSITY.
- PROVIDE ADEQUATE BLOCKING BEHIND ALL WALL MOUNTED FIXTURES
- PROVIDE ALL ACCESSORIES, HARDWARE AND MISC. ITEMS AS PER DRAWINGS AND SPECIFICATIONS. ALL ITEMS SHALL BE INSTALLED AS PER MANUFACTURERS WRITTEN INSTRUCTIONS AND CUT SHEETS.
- CONTRACTOR MUST VERIFY ALL DIMENSIONS PRIOR TO CONSTRUCTION. DO NOT SCALE DRAWINGS.
- 9. ALL CONCRETE SHALL BE 3000 PSI COMPRESSIVE STRENGTH AT 28 DAYS.
- 10. INSTALL DOORS AND WINDOWS PER MANF. DATA PROVIDED W/ PRODUCT. CENTER UNLESS NOTED
- 11. REFER TO WIND LOAD ANALYSIS FOR NAIL PATTERN AND SCHEDULE AND HOLD DOWN TABLES
- 12. ATTIC OVER CONDITIONED SPACE IS UNVENTED. ATTIC INSULATION FOAM-IN-PLACE SPRAY FOAM INSULATION.
- 13. ATTIC OVER PORCHES IS VENTED. THE TOTAL NET FREE VENTILATING AREA SHALL NOT BE LESS THAN 1/150 OF THE AREA OF THE SPACE VENTILATED. VENTILATION OPENINGS HAVING A LEAST DIMENSION LARGER THAN 1/4 INCH (6.4 MM) SHALL BE PROVIDED WITH CORROSION-RESISTANT WIRE CLOTH SCREENING, HARDWARE CLOTH, OR SIMILAR MATERIAL WITH OPENINGS HAVING A LEAST DIMENSION OF 1/16 INCH (1.6 MM) MINIMUM AND 1/4 INCH (6.4 MM) MAXIMUM.
- 14. ALL FLASHING TO MEET CODES. FOLLOW MANUFACTURER'S DATA SHEET AND SMACNA STANDARDS.
- 15. STRUCTURAL CONNECTORS LISTED ARE FOR EXAMPLE. OTHER PRODUCTS MAY BE SUBSTITUTED FOR ANY CONNECTORS LISTED PROVIDED THEY MEET THE REQUIRED LOAD CAPACITIES. FOLLOW MANUFACTURER'S INSTALLATION DATA. ANY CONNECTORS EXPOSED TO THE WEATHER SHALL BE HOT DIPPED GALVANIZED.
- 16. ANCHOR BOLT MINIMUM EMBEDMENT IS 7" UNLESS OTHERWISE NOTED.
- 17. ELECTRICAL INFORMATION IS DIAGRAMMATIC ONLY.
- 18. ALL FIXTURES AND EQUIPMENT MUST MEET THE OWNER'S APPROVAL PRIOR TO PURCHASE AND
- 19. ALL WOOD IN CONTACT WITH MASONRY OR CONCRETE SHALL BE PRESSURE TREATED. ALL STRUCTURAL WOOD EXPOSED TO WEATHER SHALL BE PRESSURE TREATED.
- 20. ALL WOOD AND WOOD CONSTRUCTION SHALL COMPLY WITH THE RELEVANT CODES AND SPECIFICATIONS AND THE 'AMERICAN INSTITUTE OF TIMBER CONSTRUCTION' (STANDARD MANUAL)
- 21. APPLICATION OF PAINT OR OTHER COATING SHALL BE IN STRICT ACCORDANCE WITH THE MANUFACTURER'S DIRECTIONS. READY-MIXED PAINT SHALL NOT BE THINNED, EXCEPT AS PERMITTED IN THE APPLICATION INSTRUCTIONS.
- 22. ALL SURFACES TO BE FINISHED SHALL BE CLEAN AND FREE OF FOREIGN MATERIALS, (DIRT, GREASE, ASPHALT, RUST, ETC.)
- 23. APPLICATION SHALL BE IN A WORKMANLIKE MANNER PROVIDING A SMOOTH SURFACE. APPLICATION RATE SHALL BE THAT RECOMMENDED BY THE MANUFACTURER. APPLICATION MAY BE BY BRUSH OR ROLLER, OR MAY BE BY SPRAY IF PAINT IS FORMULATED FOR SAME.
- 24. PROVIDE EXTERIOR AND INTERIOR SURFACE FINISHES AS SCHEDULED, AS APPROPRIATE FOR THEIR LOCATION OR EXPOSURE TO WEATHER, AND AS RECOMMENDED BY THE MANUFACTURER.
- 25. OTHER FINISHES AS PER CONSTRUCTION DOCUMENTS, FINISH SCHEDULE OR OWNER'S SPECIFICATIONS.
- 26. THE DESIGNER SHALL NOT BE RESPONSIBLE FOR AND WILL NOT HAVE CONTROL OR CHARGE OF CONSTRUCTION MEANS, METHODS, TECHNIQUES, SEQUENCES OR PROCEDURES. NOR WILL HE/SHE BE RESPONSIBLE FOR THE SAFETY PRECAUTIONS AND PROGRAMS IN CONNECTION WITH THE WORK, OR THE CONTRACTOR'S FAILURE TO CARRY OUT THE WORK IN ACCORDANCE WITH THE CONTRACT DOCUMENTS. THE DESIGNER SHALL NOT BE RESPONSIBLE FOR OR HAVE CONTROL OR CHARGE OVER THE ACTS OR OMISSIONS OF THE CONTRACTOR, SUB-CONTRACTORS, OR ANY OF THEIR AGENTS OR EMPLOYEES, OR ANY OTHER PERSONS PERFORMING ANY OF THE WORK.





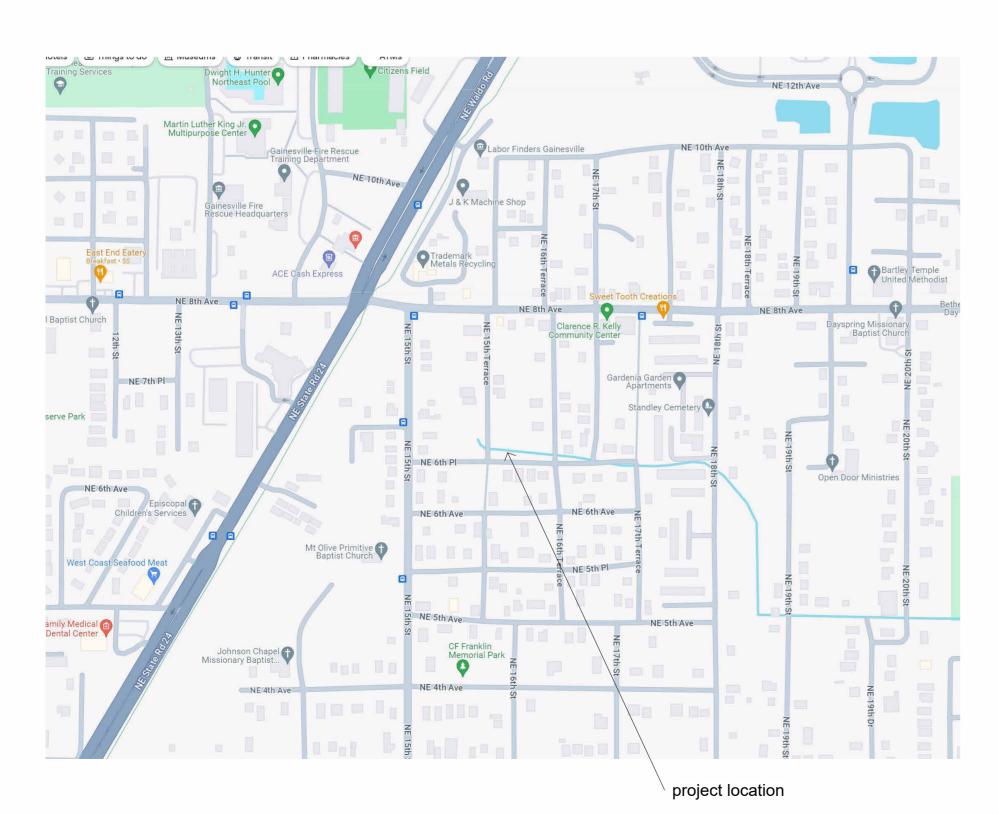


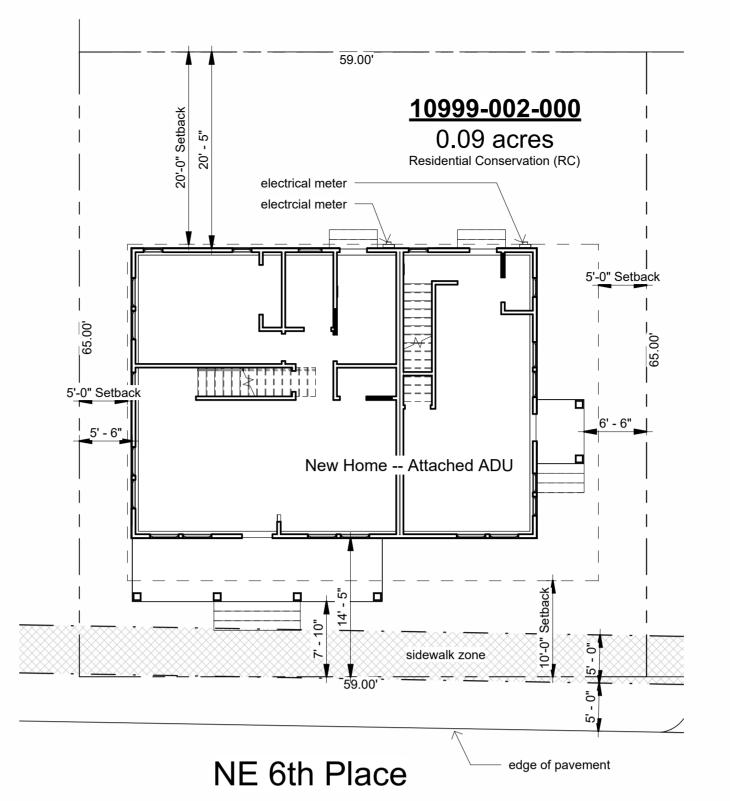

Site



Sketch 1

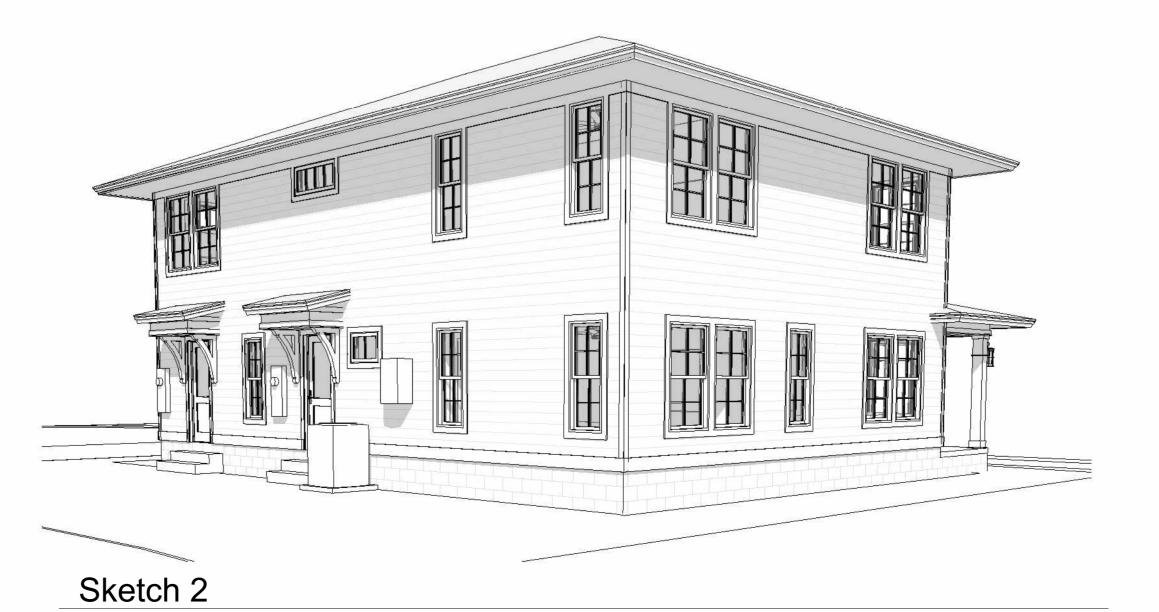

<u>Project Identification</u> Douglas Residence

Project Location

Gainesville, Florida

<u>Owner</u>

Jonathan Douglas, 832 NW 39th Ave LLC 9200 NW 39th Ave. STE 130-3255 Gainesville, FL 32606

<u>Designer</u>

Bob Harris - dba Bob Harris Design 2351 SW 56th Avenue Gainesville, Florida 32608

Building Code

All areas of construction shall comply with Florida Building Code 8th Addition 2023

Project Scope

New HomeAttached ADU


	Sheet List
Sheet Number	Sheet Name
A0	Cover, Location, Notes
Δ1	First Floor Plan

A0	Cover, Location, Notes
A1	First Floor Plan
A2	Second Floor Plan
A3	Elevations
A4	Electrical Plan

tl	Name	Level
ADU		
425 SF	ADU	Second Floor
425 SF	ADU	First Floor
850 SF	'	

Area Schedule (Gross Building)

Home		
835 SF	Home	First Floor
835 SF	Home	Second Floor
1670 SF	·	
2520 SF		

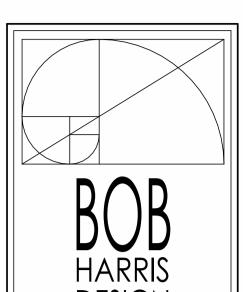

bobharrisdesign.com bh@bobharrisdeign.com 352-317-6644 2351 SW 5th Avenue

CLIENT
Jonathan Douglas, 832
NW 39th Ave LLC

ouglas Residencot 23 West Home

Revision Date

Number Date

Date:

O1/23/2024

Drawn:
Bob Harris

Cover, Location, Notes

Description:

SHEET


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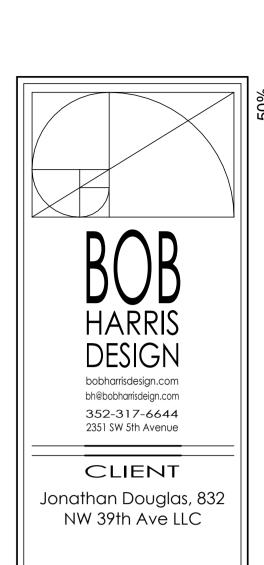
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				Window Schedule		
ark	Width	Height	Description	Comments	Head Height	Count
	3' - 0"	5' - 0"	Single Hung		6' - 8"	20
	2' - 0"	5' - 0"	Single Hung		6' - 8"	9
	3' - 0"	3' - 0"	Single Hung		6' - 8"	2
	4' - 0"	1' - 8"	Awning		6' - 8"	3
	3' - 0"	1' - 8"	Casement Left		6' - 8"	2
	3' - 0"	1' - 8"	Casement Right		6' - 8"	2
	2' - 6"	1' - 8"	Awning		6' - 8"	1
	2' - 8"	3' - 0"	Single Hung		6' - 8"	2

Mark	Width	Height	Function	Location	Description	Comments
First F						
01	3' - 0"	6' - 8"	Exterior	Entry Porch 1		
02	2' - 8"	6' - 8"	Exterior	Entry Porch 2		
03	2' - 8"	6' - 8"	Exterior	Kitchen 2		
04	2' - 8"	6' - 8"	Exterior	Utility		
05	2' - 8"	6' - 8"	Interior	Bath 1		
06	2' - 8"	6' - 8"	Interior	Bedroom 1		
07	5' - 0"	6' - 8"	Interior	Closet 1	Pair Sliding Doors	
80	2' - 6"	6' - 8"	Interior	Laundry		
09	2' - 8"	6' - 8"	Interior	Pantry	Pocket Door Full Lite Frosted Glass	
10	2' - 6"	6' - 8"	Interior	Pdr.	Pocket Door	
11	2' - 0"	6' - 0"	Interior	Under Stair Clo.		
12	2' - 8"	6' - 8"	Interior	Utility	Full Light Frosetd Glass, Pocket Door	
Seco	nd Floor					
13	2' - 6"	6' - 8"	Interior	Bath 1a		
14	2' - 6"	6' - 8"	Interior	Bath 2		
15	5' - 0"	6' - 8"	Interior	Bedroom 1a	Pair Sliding Doors	
16	2' - 6"	6' - 8"	Interior	Bedroom 1a		
17	2' - 8"	6' - 8"	Interior	Bedroom 2		
18	2' - 6"	6' - 8"	Interior	Bedroom 2a		
19	2' - 8"	6' - 8"	Interior	Bedroom 3		
20	5' - 0"	6' - 8"	Interior	Closet 2	Pair Sliding Doors	
21	2' - 6"	6' - 8"	Interior	Closet 2a	Pocket Door	
22	2' - 0"	6' - 8"	Interior	Closet 3		
23	1' - 8"	6' - 8"	Interior	Landing 2		
24	2' - 6"	6' - 8"	Interior	M. Bath	Pocket Door	
25	2' - 8"	6' - 8"	Interior	Master Bedroom		
26	3' - 0"	6' - 8"	Interior	Mech 1		
28	2' - 8"	6' - 8"	Interior	Mech.		
29	2' - 4"	6' - 8"	Interior	W.I.C.		





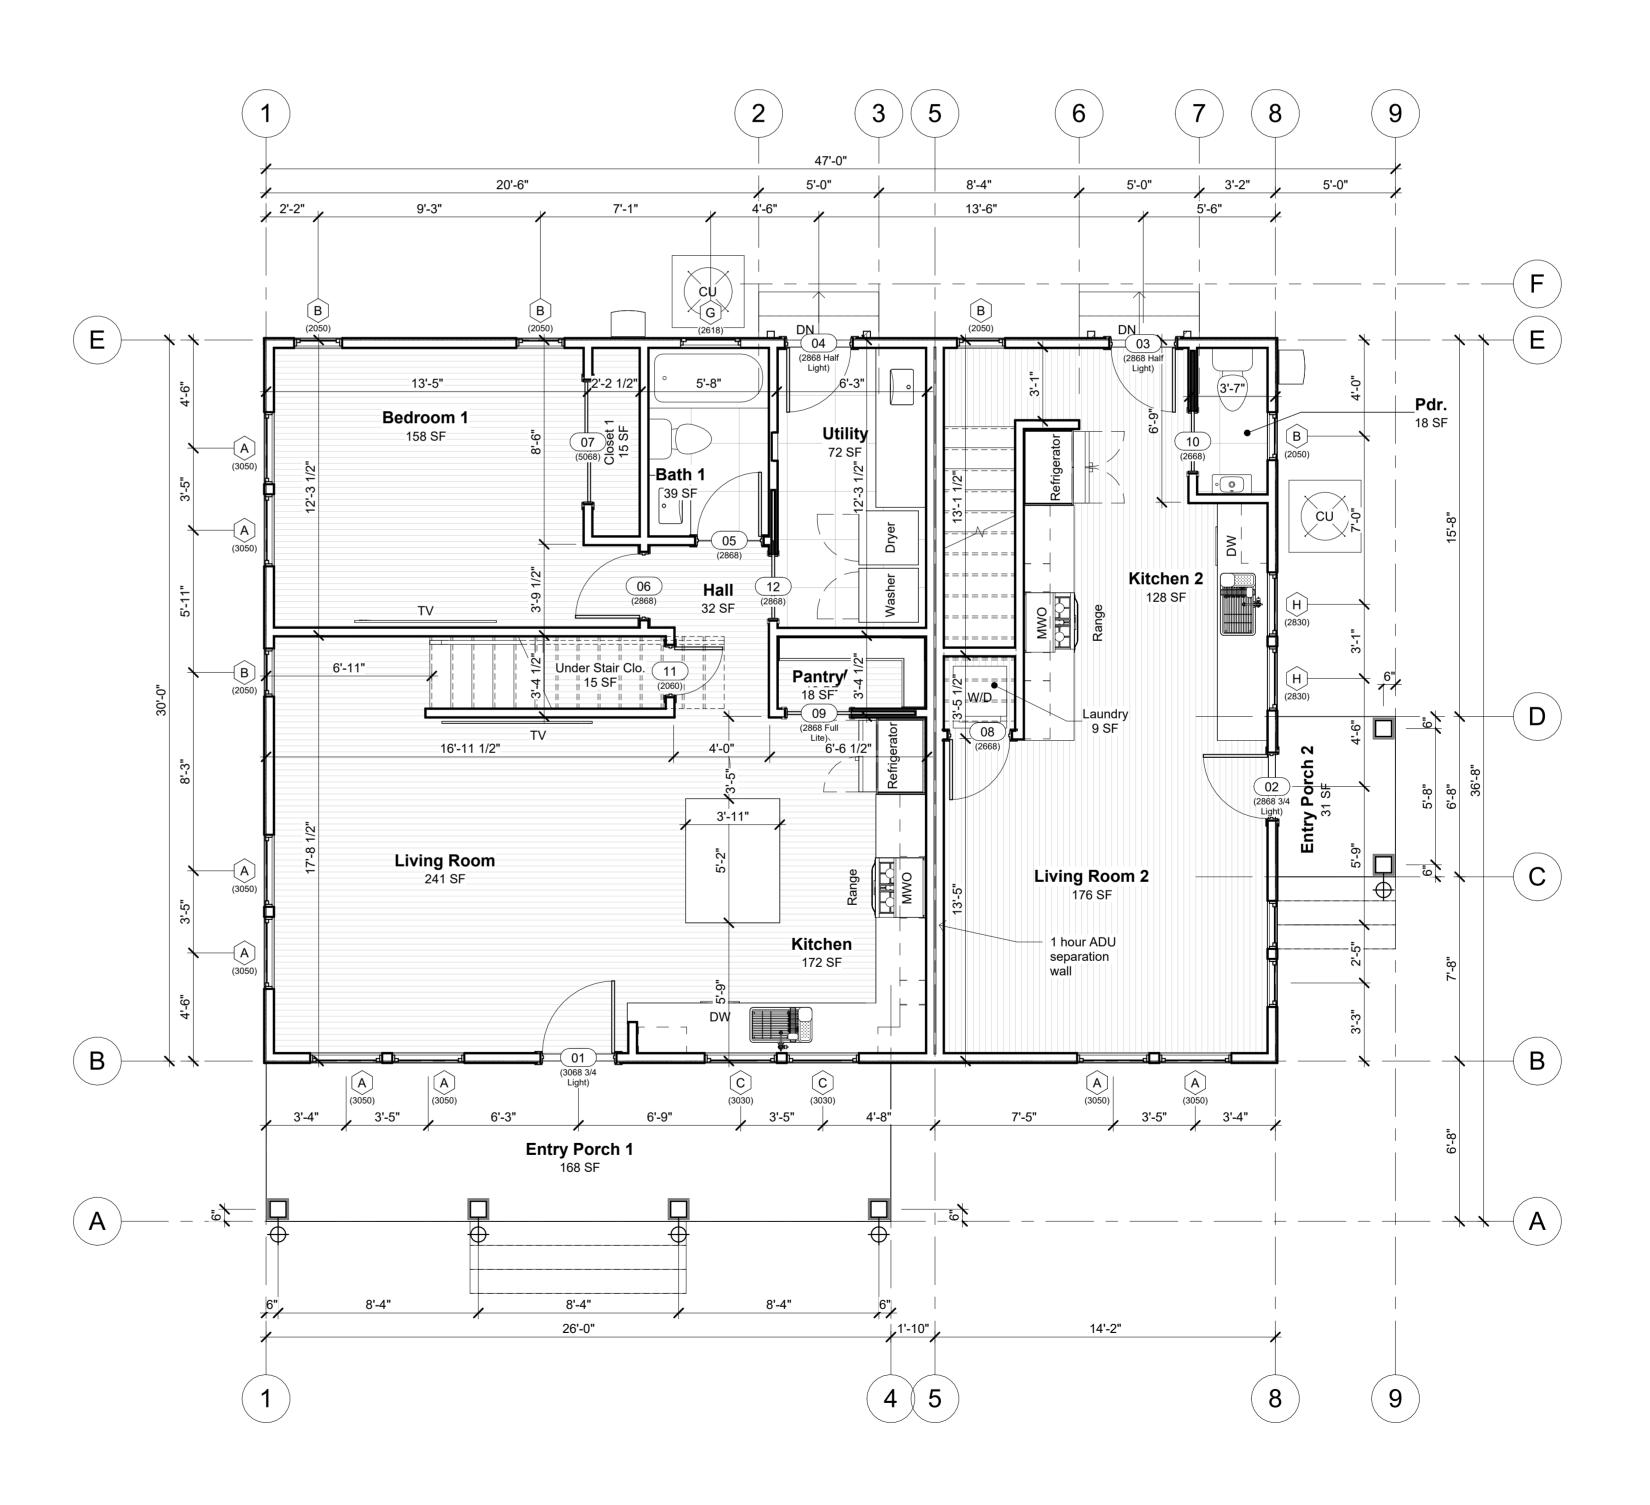

Douglas Residenc Lot 23 West Home

Revision Date

Number Date

Date: 01/23/2024

Drawn:

Bob Harris

Description:

First Floor Plan


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	Window Schedule					
Mark	Width	Height	Description	Comments	Head Height	Count
Α	3' - 0"	5' - 0"	Single Hung		6' - 8"	20
В	2' - 0"	5' - 0"	Single Hung		6' - 8"	9
С	3' - 0"	3' - 0"	Single Hung		6' - 8"	2
D	4' - 0"	1' - 8"	Awning		6' - 8"	3
E	3' - 0"	1' - 8"	Casement Left		6' - 8"	2
F	3' - 0"	1' - 8"	Casement Right		6' - 8"	2
G	2' - 6"	1' - 8"	Awning		6' - 8"	1
Н	2' - 8"		Single Hung		6' - 8"	2

Mark	Width	Height	Function	Location	Description	Comments
First F			I			
01		6' - 8"	Exterior	Entry Porch 1		
02		6' - 8"	Exterior	Entry Porch 2		
03		6' - 8"	Exterior	Kitchen 2		
04		6' - 8"	Exterior	Utility		
05		6' - 8"	Interior	Bath 1		
06		6' - 8"	Interior	Bedroom 1		
07		6' - 8"	Interior	Closet 1	Pair Sliding Doors	
80		6' - 8"	Interior	Laundry		
09		6' - 8"	Interior	Pantry	Pocket Door Full Lite Frosted Glass	
10	2' - 6"	6' - 8"	Interior	Pdr.	Pocket Door	
11	2' - 0"	6' - 0"	Interior	Under Stair Clo.		
12	2' - 8"	6' - 8"	Interior	Utility	Full Light Frosetd Glass, Pocket Door	
Seco	nd Floor					
13	2' - 6"	6' - 8"	Interior	Bath 1a		
14	2' - 6"	6' - 8"	Interior	Bath 2		
15	5' - 0"	6' - 8"	Interior	Bedroom 1a	Pair Sliding Doors	
16	2' - 6"	6' - 8"	Interior	Bedroom 1a		
17	2' - 8"	6' - 8"	Interior	Bedroom 2		
18	2' - 6"	6' - 8"	Interior	Bedroom 2a		
19	2' - 8"	6' - 8"	Interior	Bedroom 3		
20	5' - 0"	6' - 8"	Interior	Closet 2	Pair Sliding Doors	
21	2' - 6"	6' - 8"	Interior	Closet 2a	Pocket Door	
22	2' - 0"	6' - 8"	Interior	Closet 3		
23	1' - 8"	6' - 8"	Interior	Landing 2		
24	2' - 6"	6' - 8"	Interior	M. Bath	Pocket Door	
25	2' - 8"	6' - 8"	Interior	Master Bedroom		
26	3' - 0"	6' - 8"	Interior	Mech 1		
28		6' - 8"	Interior	Mech.		
29		6' - 8"	Interior	W.I.C.		



Second Floor Plan

1/4" = 1'-0"

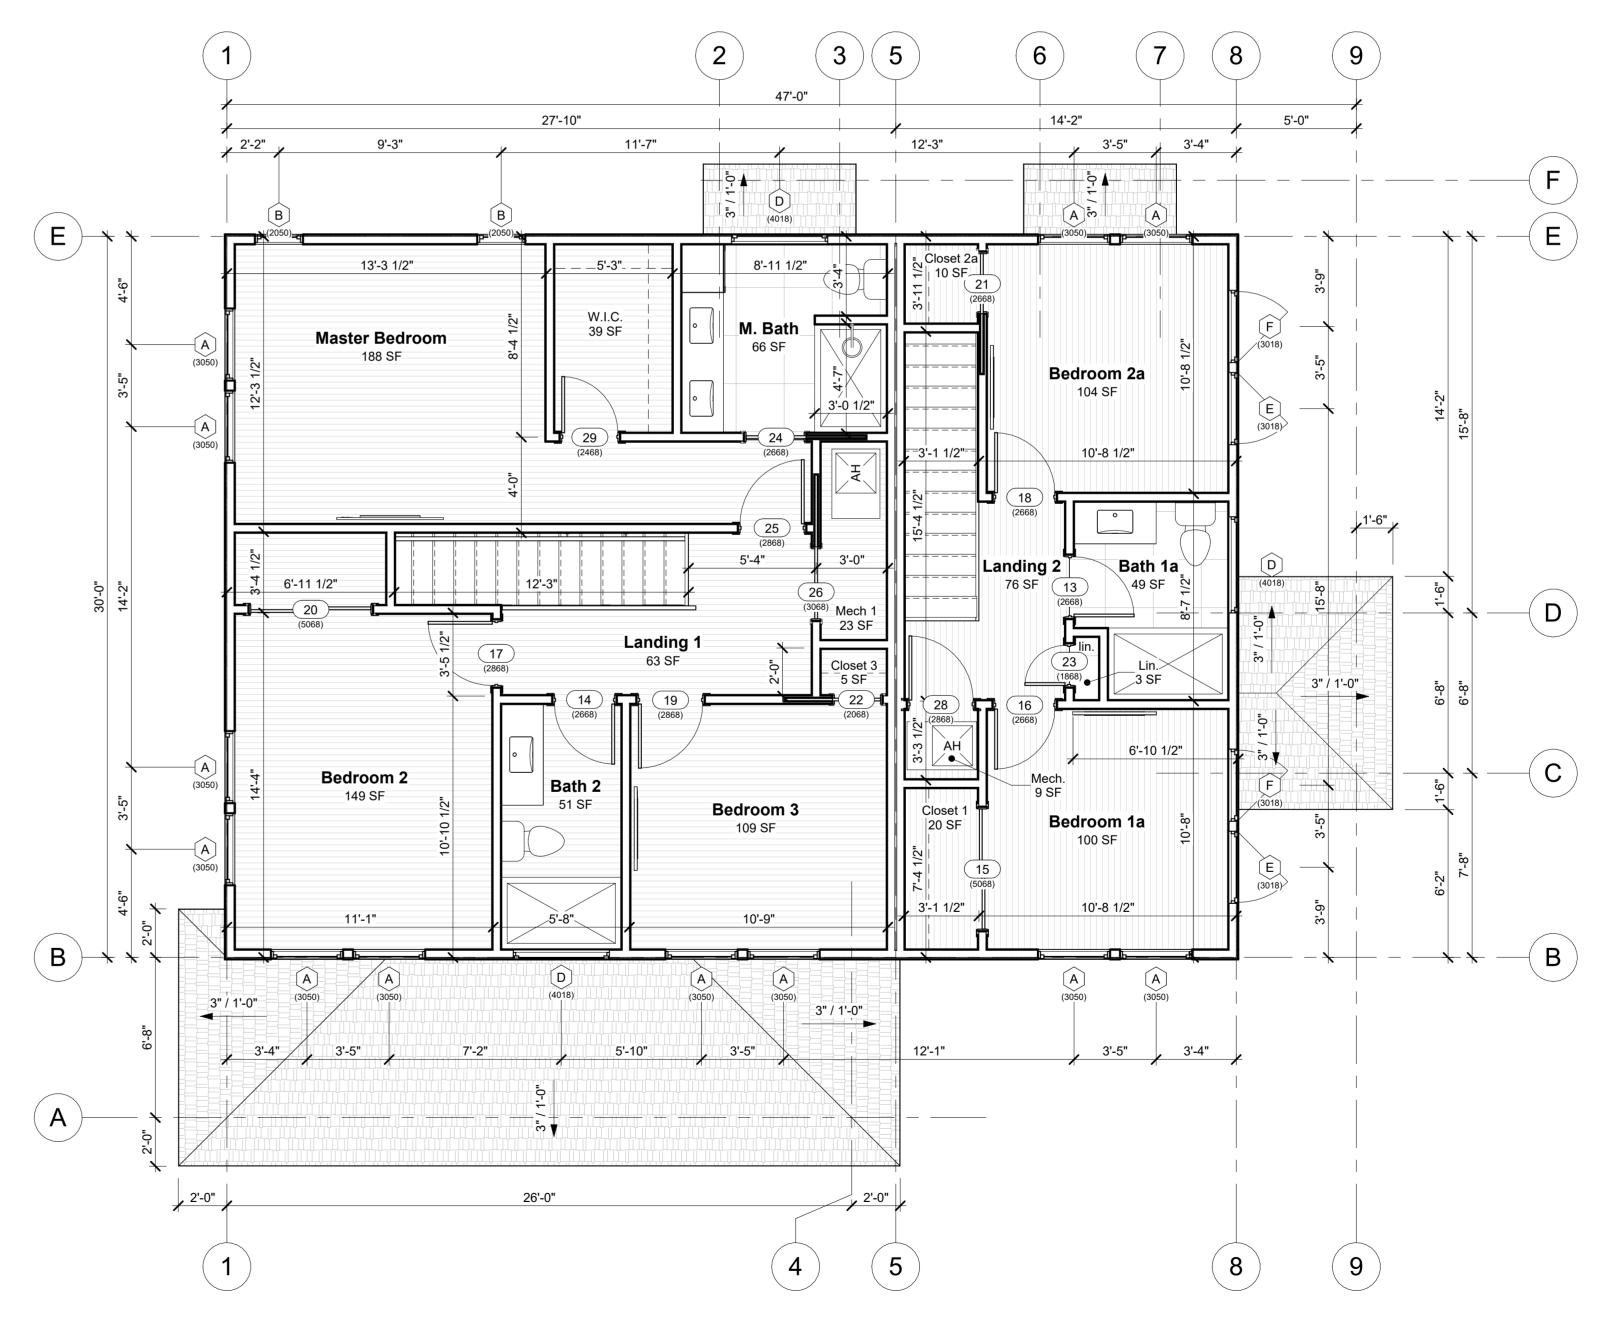DESIGN bobharrisdesign.com

> 352-317-6644 2351 SW 5th Avenue CLIENT

bh@bobharrisdeign.com

Jonathan Douglas, 832 NW 39th Ave LLC

Re

Revision Date Number Date

Date: 01/23/2024 Drawn:

Bob Harris Description:


Second Floor Plan


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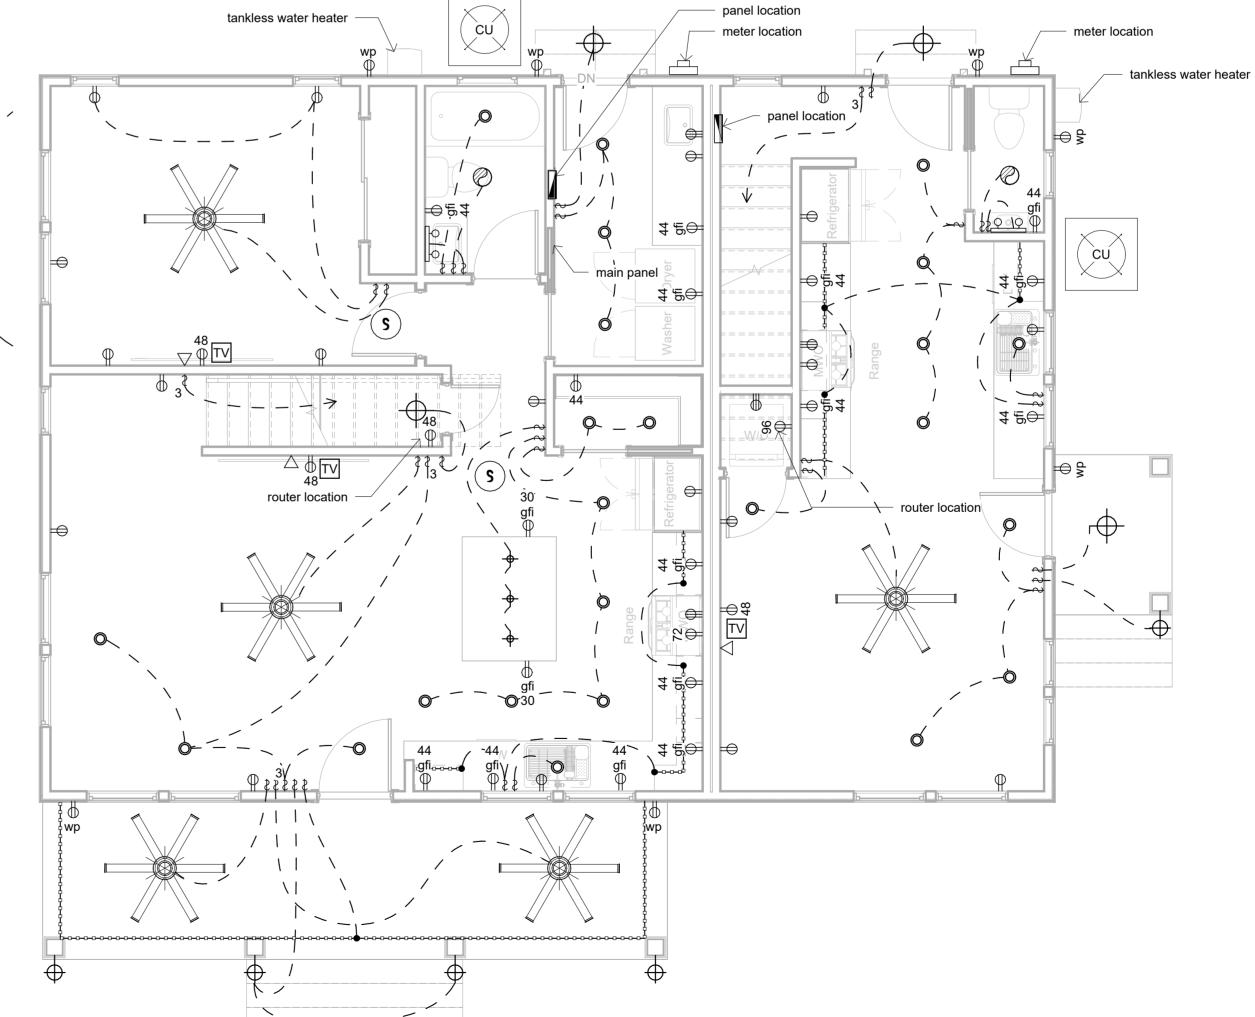
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- Electrical Genral Notes:
 All receptacle outlets not indicated as gfi (ground fault interrupted) shall be afci (arc fault circuit interrupted)
 All receptacle outlets indicated as WP are Ground Fault Interrupted
 Verify w/ Owner light fixtures to receive dimmers
 Home run all CAT6 data connections to router location. Provide data connection to outside for Cable, Satellite and DSL Internet.

Electrical Plan Second Floor



Electrical Plan First Floor

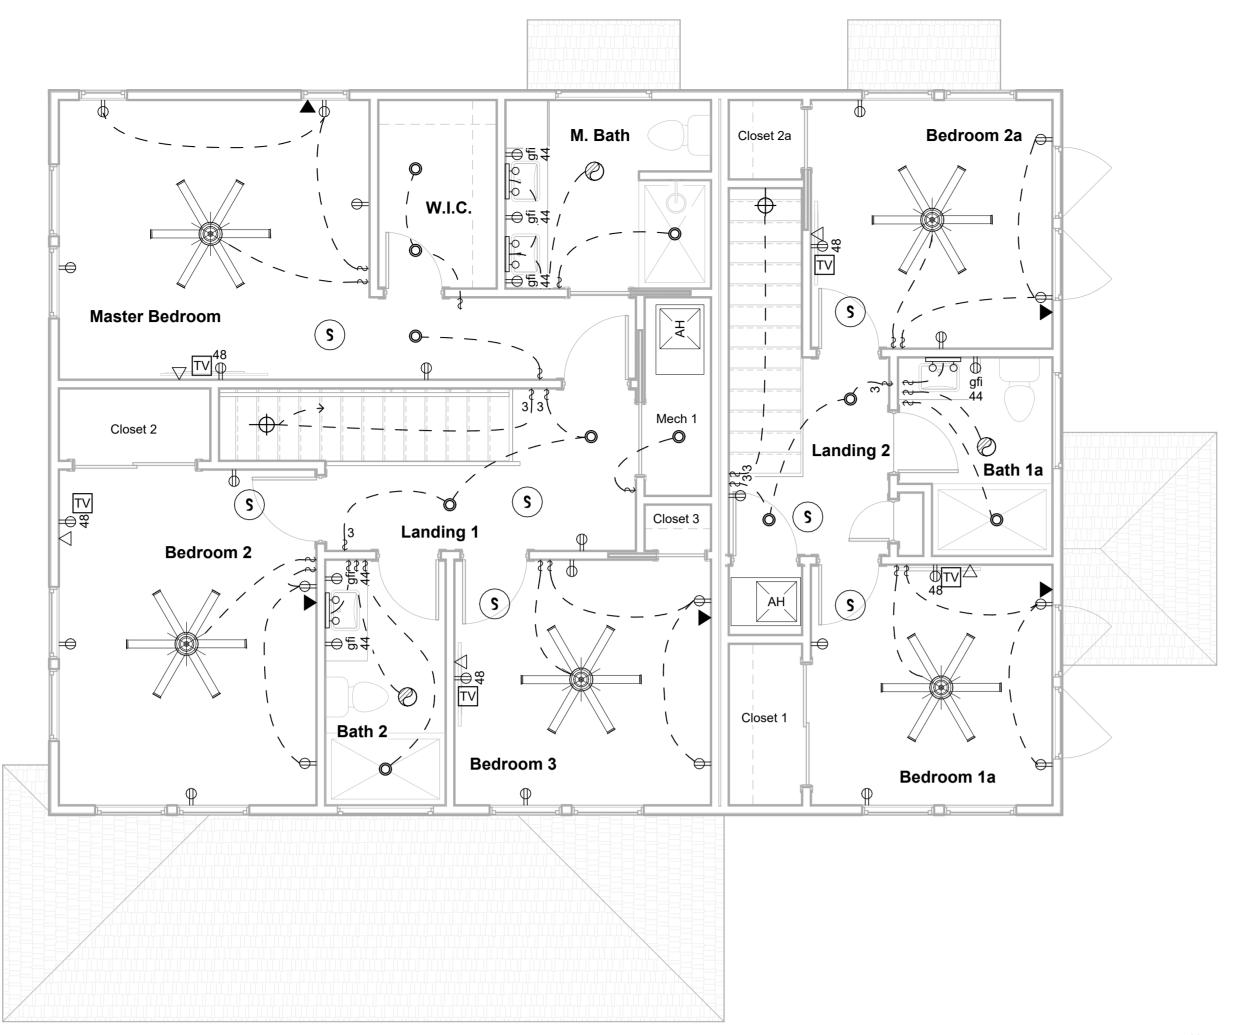1/4" = 1'-0"

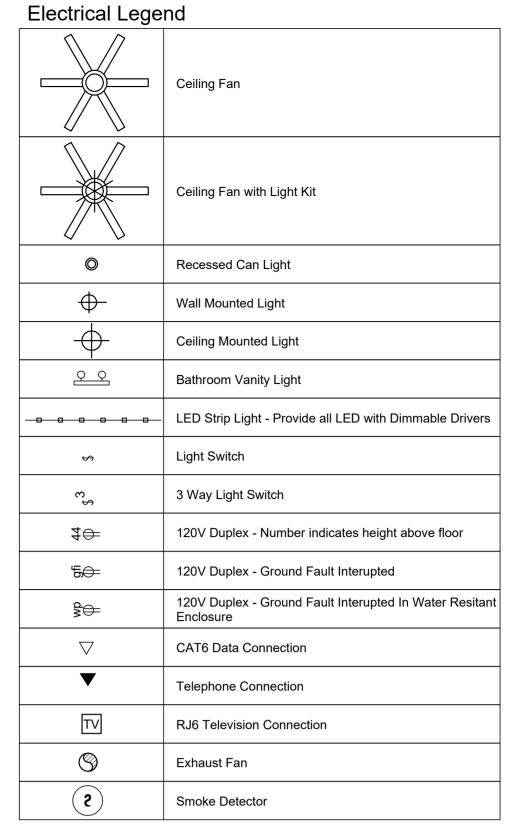